

MONTEREY REGIONAL WATER
POLLUTION CONTROL AGENCY
Monterey County, California

EXHIBIT B -
EXISTING DRAINAGE
SYSTEM

CONTRACT DOCUMENTS FOR THE CONSTRUCTION OF

**MARINA COUNTY WATER DISTRICT
CONNECTION FACILITIES**

VOLUME 3 OF 3

PART C - DRAWINGS
GENERAL-ARCHITECTURAL-STRUCTURAL-PIPING, PROCESS AND
INSTRUMENTATION DIAGRAM-MECHANICAL-ELECTRICAL

January 1992





Brown and Caldwell

Copy No.



PART C - INDEX OF DRAWINGS

SHEET NUMBER	DRAWING NUMBER	TITLE	SHEET NUMBER	DRAWING NUMBER	TITLE	
GENERAL						
1	G1	GENERAL COVER SHEET	36	M1	STANDARD PIPE HANGERS	
2	G2	VICINITY MAP, LOCATION MAP, AND INDEX OF DRAWINGS	37	M2	STANDARD STRUCTURAL PIPE ATTACHMENTS	
3	G3	STANDARD ABBREVIATIONS	38	M3	PIPE PENETRATIONS AND MISCELLANEOUS DETAILS	
4	G4	STANDARD SYMBOLS AND DRAWING CONVENTIONS	39	M4	MISCELLANEOUS DETAILS	
5	<u>G5</u>	PLAN AND PROFILE 1	40	M5	HVAC DESIGNATIONS, DIFFUSER SCHEDULE, AND VENTILATION EQUIPMENT DETAILS	
6	<u>G6</u>	<u>PLAN AND PROFILE 2</u>	RESERVATION ROAD PUMPING STATION			
7	G7	<u>MISCELLANEOUS DETAILS 1</u>	41	M101	LOWER FLOOR PIPING PLAN	
8	G8	<u>MISCELLANEOUS DETAILS 2</u>	42	M102	GROUND FLOOR PLAN	
9	G101	<u>MISCELLANEOUS DETAILS 3</u>	43	M103	LOWER FLOOR HVAC PLAN	
10	G102	SITE PLAN	44	M104	SECTION	
11	<u>G103</u>	LANDSCAPE PLANTING PLAN	45	M105	SECTIONS 1	
12	<u>G104</u>	LANDSCAPE AND IRRIGATION DETAILS 1	46	M106	SECTIONS 2	
13	<u>G105</u>	LANDSCAPE AND IRRIGATION DETAILS 2	47	M107	FUEL STORAGE TANK SECTIONS AND DETAILS	
14	A101	LANDSCAPE AND IRRIGATION DETAILS 3	48	M110	AIRFLOW SCHEMATIC	
MECHANICAL						
14	A101	ARCHITECTURAL	49	E1	ELECTRICAL	
15	A102	RESERVATION ROAD PUMPING STATION	50	E2	ELECTRICAL SYMBOLS AND ABBREVIATIONS	
16	A103	LOWER FLOOR PLAN	51	E3	ELECTRICAL SYMBOLS	
17	A104	GROUND FLOOR PLAN AND DOOR SCHEDULE	52	E4	CONSTRUCTION DETAILS 1	
18	A105	EXTERIOR ELEVATIONS	53	E5	CONSTRUCTION DETAILS 2	
19	S1	ROOF PLAN AND SECTION	54	E6	CONSTRUCTION DETAILS 3	
20	S2	MISCELLANEOUS DETAILS	55	E7	CONSTRUCTION DETAILS 4	
21	S3	STRUCTURAL	56	E8	INSTRUMENT PANEL 601 AND TELEMETRY PANEL 603	
22	S4	GENERAL STRUCTURAL NOTES	57	E9	SINGLE LINE DIAGRAM	
23	S101	TYPICAL CONCRETE DETAILS	58	E10	CONTROL DIAGRAMS 1	
24	S102	TYPICAL METALWORK DETAILS	59	E11	CONTROL DIAGRAMS 2	
25	S103	MISCELLANEOUS DETAILS	60	E12	CONTROL DIAGRAMS 3	
26	S104	RESERVATION ROAD PUMPING STATION	61	E13	CONTROL DIAGRAMS 4	
27	S105	FOUNDATION PLAN AND SECTIONS	62	E14	CONTROL DIAGRAMS 5	
28	S106	GROUND FLOOR PLAN AND SECTIONS	63	E15	CONTROL DIAGRAMS 6	
29	S107	ROOF FRAMING PLANS, SECTIONS, AND DETAILS	64	E16	SITE PLAN	
30	P1	SECTIONS AND DETAILS 1	65	E17	RESERVATION ROAD PUMPING STATION	
31	P2	SECTIONS AND DETAILS 2	66	E18	LOWER FLOOR PLANS POWER, CONTROL, AND SIGNAL	
32	P11	SECTIONS	67	E19	GROUND FLOOR POWER, CONTROL, AND SIGNAL PLAN	
33	P12	SECTIONS AND DETAILS	68	E20	GROUNDING PLANS	
34	P13	PIPING, PROCESS, AND INSTRUMENTATION DIAGRAMS	69	E21	LOWER FLOOR LIGHTING PLAN	
35	P14	PIPE AND MECHANICAL SYMBOLS	70	E22	GROUND FLOOR LIGHTING PLAN	
36	P15	INSTRUMENTATION SYMBOLS AND IDENTIFICATION SYSTEM	71	E23	PART PLANS ELECTRICAL ROOM POWER, CONTROL,	
37	P16	PRIMARY PUMPING 1	72	E24	AND SIGNAL PLANS	
38	P17	PRIMARY PUMPING 2	73	E25		
39	P18	UTILITY WATER SYSTEM	74	E26		
40	P19	DRAINAGE AND STANDBY GENERATOR SYSTEMS	75	E27		

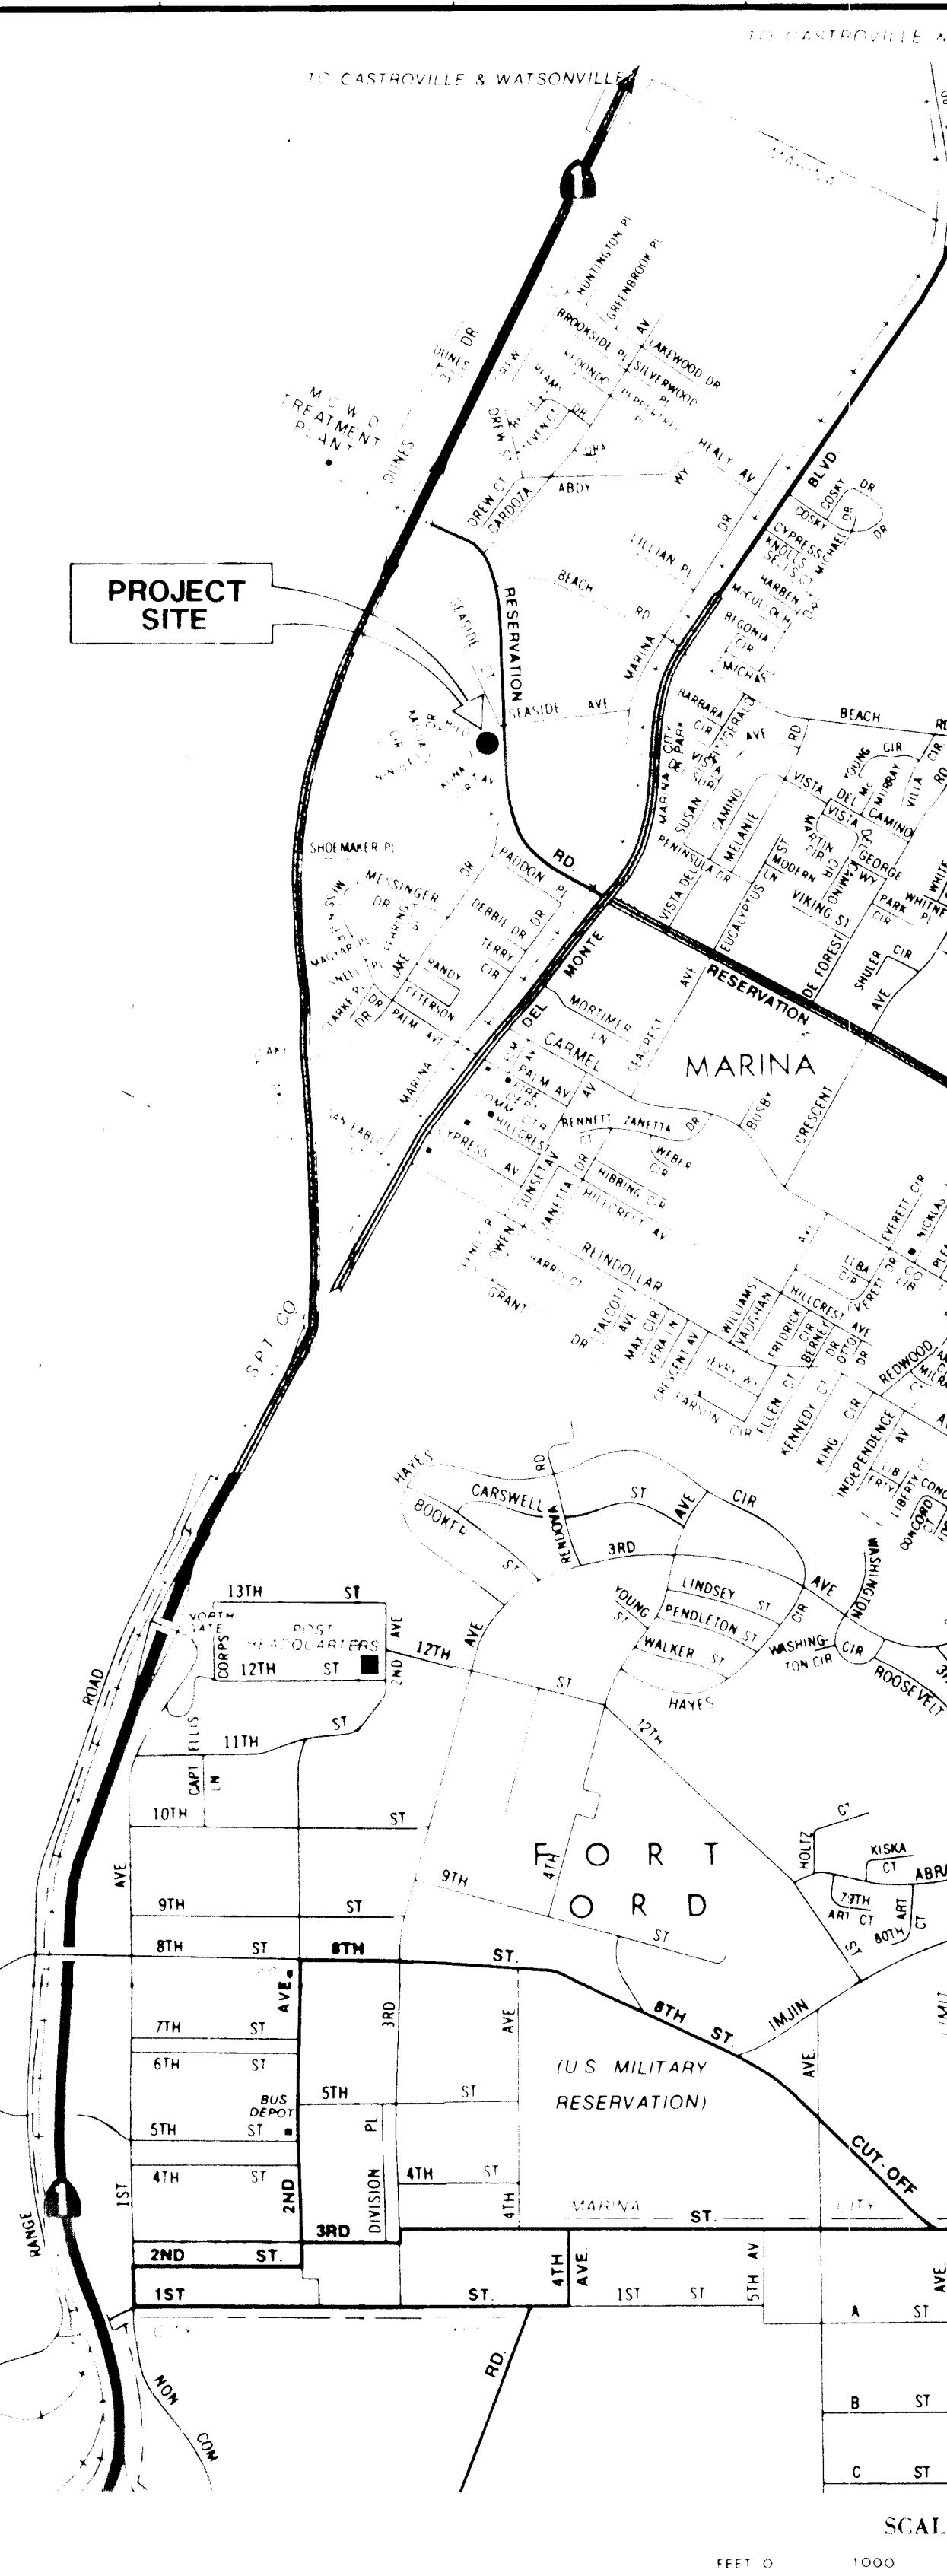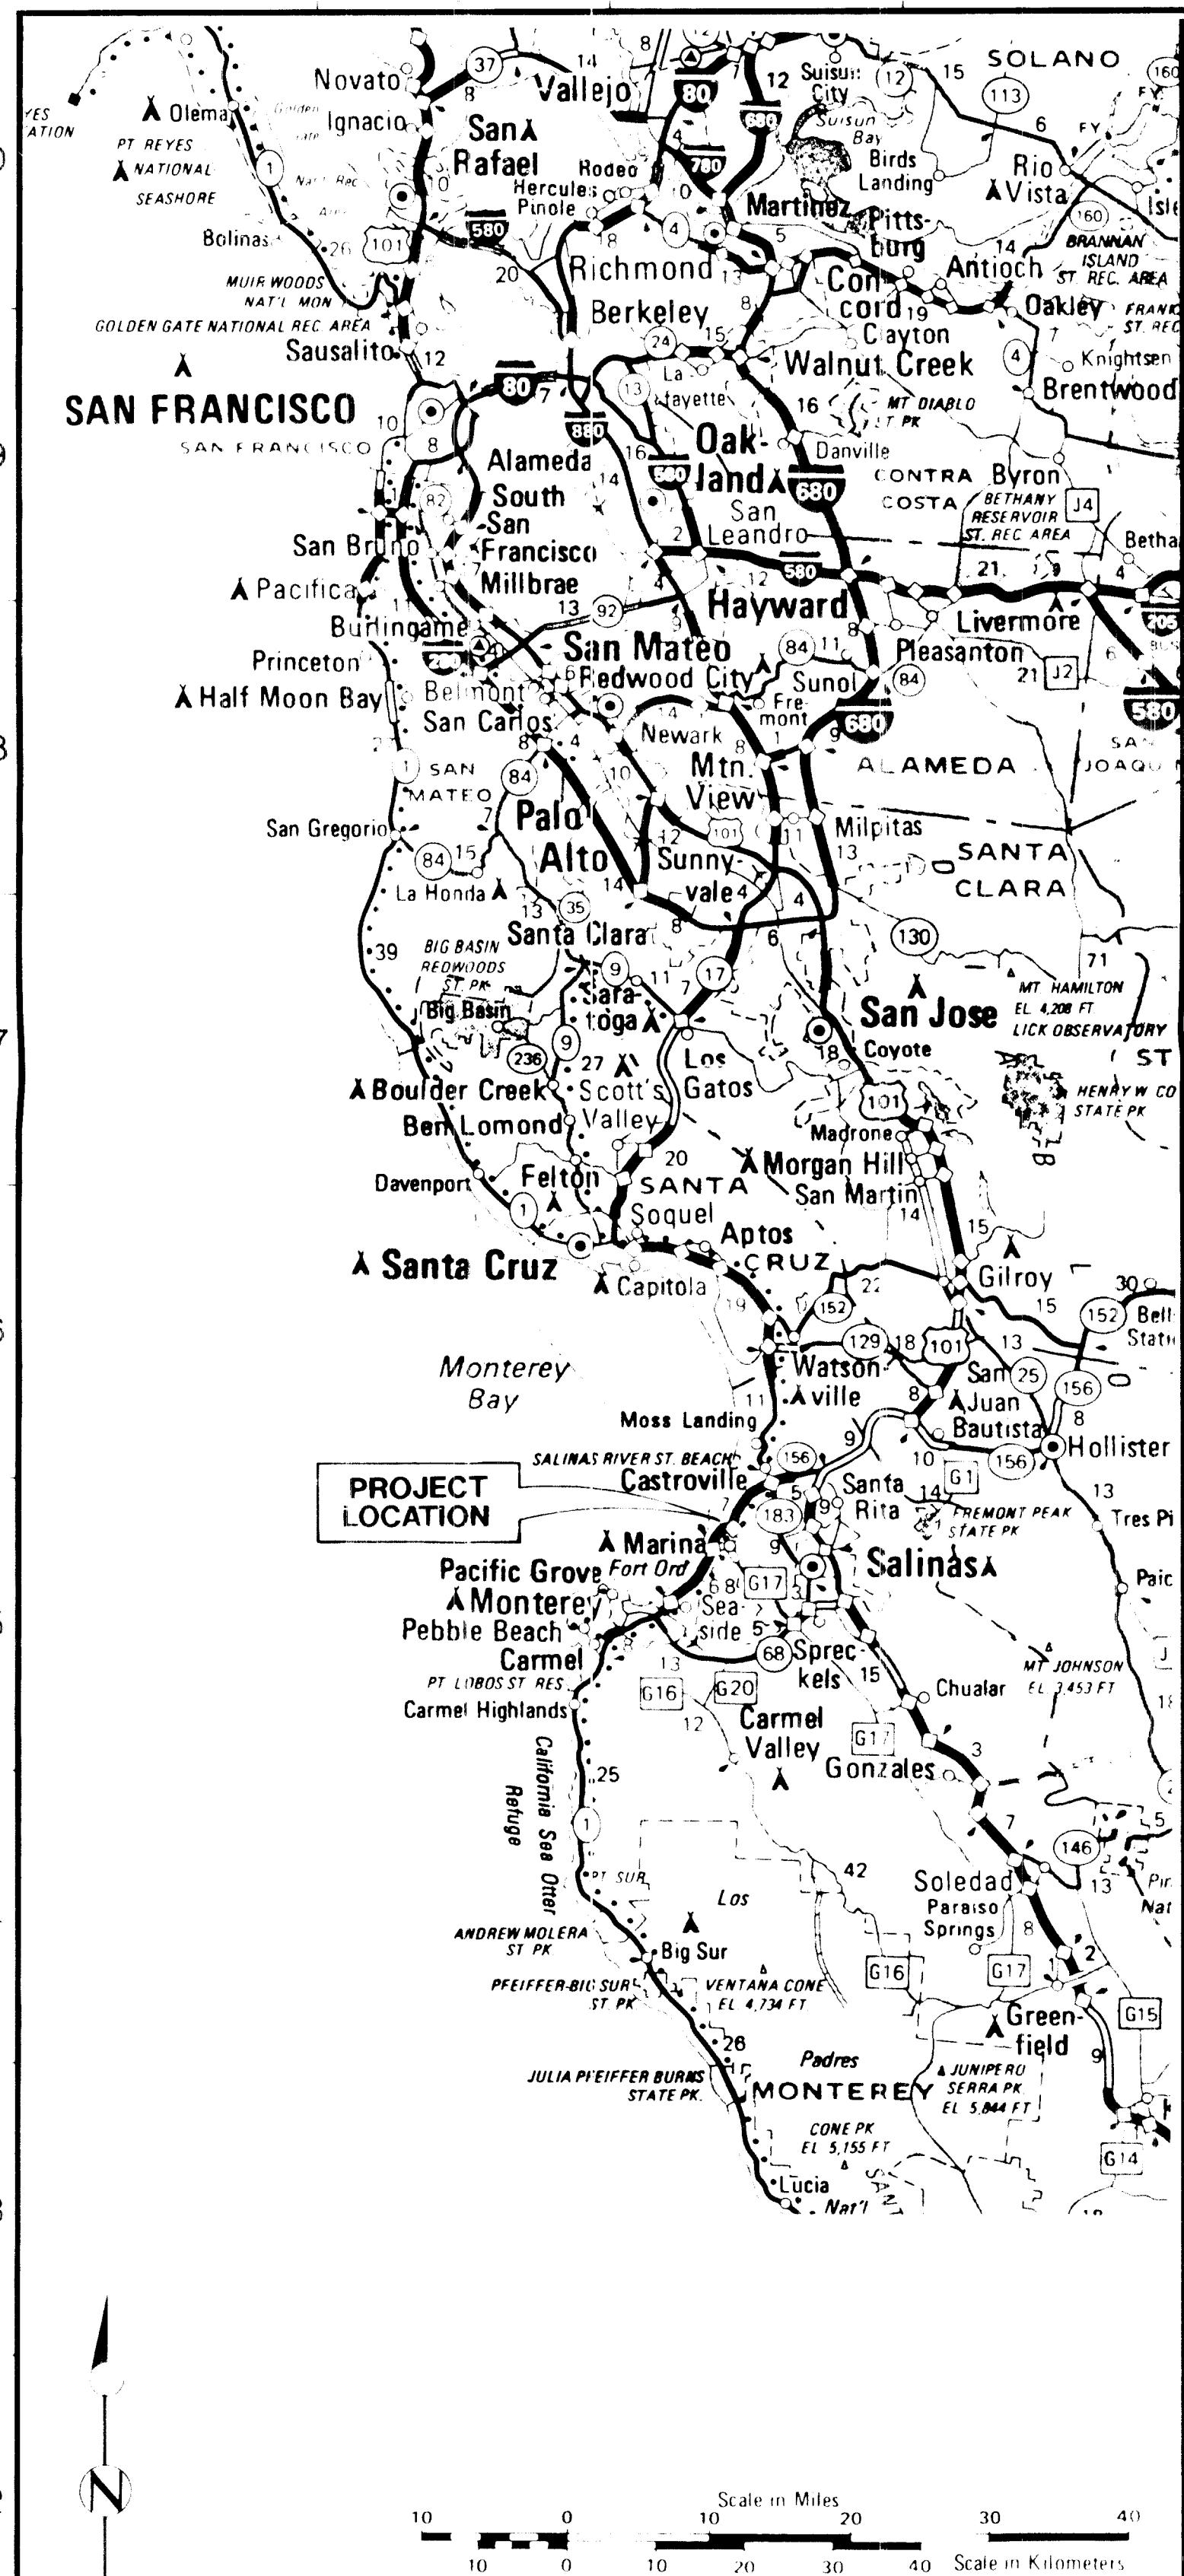

BC Brown and Caldwell Consultants		LINE IS 2 INCHES AT FULL SIZE (ENHANCED SCALING) FILE: 5478 DRAWN: MBCHAVES DESIGNED: TMK/MBC CHECKED: APPROVED: APPROVED: DATE: 1-14-92 DATE: 1-14-92 DATE: 1-14-92 DATE: 1-14-92	REGISTERED PROFESSIONAL ENGINEER No. 13360 CIVIL STATE OF CALIFORNIA TIMOTHY M. KELLY No. 27991 EXP. 3-31-94	ZONE REV. REVISIONS DESCRIPTION BY DATE APP.	MCWD CONNECTION FACILITIES MONTEREY REGIONAL WATER POLLUTION CONTROL AGENCY MONTEREY COUNTY, CALIFORNIA		GENERAL VICINITY MAP, LOCATION MAP AND INDEX OF DRAWINGS	SCALE DRAWING NUMBER G1 SHEET NUMBER
-----------------------------------	--	--	--	---	--	--	--	---

A	ATOMIC ABSORPTION UNIT	DG	DOOR GRILLE	HC	HEATING COIL	OD	OUTSIDE DIAMETER	SSFH	STAINLESS STEEL FLAT HEAD
A	AMPERE	DIA	DIAMETER	HD	HEAVY DUTY	OF	OUTSIDE FACE	SSK	SERVICE SINK
AB	ANCHOR BOLT, AGGREGATE BASE	DIAG	DIAGRAM	HDOT	HEAVY DUTY OILTIGHT	OL	OVERTLOAD	ST	START
AC	ASPHALT CONCRETE, ALTERNATING CURRENT, AIR CONDITIONER	DIFF	DIFFERENTIAL	HER	HEADER	OPNG	OPENING	STA	STATION
A/C	AIR CONDITIONING	DLD	DEDICATED LAND DISPOSAL	HEX	HEAT EXCHANGER	OPP	OPPOSITE	STD	STANDARD, STORM DRAIN
ACC	AREA CONTROL CENTER	DM	DAMP'R MOTOR	HOA	HAND-OFF-AUTO	ORF	ODOR REMOVAL FILTER	STFR	STIFFEN'R
ACP	ASBESTOS CEMENT PIPE	DN	DOWN	HOR	HORIZONTAL	ORP	OXIDATION REDUCTION POTENTIAL	STRUCT	STRUCTURE
ACST	ACOUSTIC	DO	DISSOVED OXYGEN	HP	HIGH PRESSURE, HIGH POINT, HORSEPOWER	ORT	ODOR REMOVAL TOWER	SUB	SUBSTITUTE, SUBSTATION
ADWF	AVERAGE DRY WEATHER FLOW	DPR	DAMPER	HR	HANDRAIL, HEAT RESERVOIR, HOUR	ORU	ODOR REDUCTION UNIT	SUPRT	SUPPORT
AF	AIR FILTER	DR	DRAIN ROCK, DOOR	HST	HOIST	OSA	OUTSIDE AIR	SV	SURFACE
AHU	AIR HANDLING UNIT	DT	DRAIN TRAP, DRIP TRAP	HT	HEIGHT, HIGH	P	PUMP, PHASE, PROCESS	SWR	SWITCHBOARD
AL	ALUMINUM	DWG	DRAWING	HTR	HEATER	PAR	PARALLEL	SYM	SYMMETRICAL
ALUM	ALUMINUM SULPHATE	DWLS	DOWELS	HTV	HIGH TEMPERATURE VENT	PC	PLAIN CONCRETE, PIPE COUPLING	T	TANK, TRAP
ALT	ALTERNATE	EA	EXHAUST AIR, EACH	HVAC	HEATING, VENTILATING, AND AIR CONDITIONING	PCC	PLANT CONTROL CENTER	T & B	TOP AND BOTTOM
AMD	AIR MONITORING DEVICE	EAT	ENTERING AIR TEMPERATURE	HWTR	HIGH WATER	PCHV	PINCH VALVE	TB	TERMINAL BOX
ANC	ANCHOR	EAU	ENGINE ALTERNATOR UNIT	HYD	HYDRAULIC	PCP	PLAIN CONCRETE PIPE	TBR	TOP OF BANK
APPROX	APPROXIMATE(LY)	ECC	END OF CURVE, EVAPORATIVE COOLER	HYDT	HYDRANT	PC-T	PIPE COUPLING TO TAKE TENSION	TC	TOP OF CURB
AR	ALARM RELAY	ED	EXTRACTOR DAMPER, EQUIPMENT DRAIN	I	INTEGRAL CONTROL	PCU	PHOTOELECTRIC CONTROL UNIT	TCL	TOTALLY CLOSED
AS	AIR SUPPLY	EE	EACH END	IA	INSTRUMENT AIR	PE	PNEUMATIC/ELECTRICAL CONVERTER	TOP	TEMPERATURE CONTROL PANEL
ASSY	ASSEMBLY	EF	EACH FACE	ID	INSIDE DIAMETER	PF	POWER FACTOR, PRESSURIZED FLOW	TD	TIME DELAY RELAY, TANK DRAIN,
ATM	ATMOSPHERE	EFF	EFFLUENT	INJ	INCINERATOR	PG	PRESSURE GAGE	TE	TEMPERATURE DIFFERENCE
AV	ANGLE VALVE	EG	EXHAUST GRILLE	IF	INSIDE FACE	P&ID	PROCESS AND INSTRUMENTATION DIAGRAM	TE	TOTALLY ENCLOSED, THICKENER EFFLUENT
B	BLOWER	EJ	EXPANSION JOINT	IL	INDICATING LAMP	PIVC	POINT OF INTERSECTION ON VERTICAL CURVE	TI	TEMPERATURE INDICATOR
BC	BEGINNING OF CURVE	EL	ELEVATION	IN	INCH	PL	PROPERTY LINE, PIPELINE, PLATE	TOA	TEST-OFF-AUTO
BCOP	BARE COPPER	ELEC	ELECTRICAL	INF	INFILUNT	PLYWD	PLYWOOD	TP	TANGENT POINT
BCR	BEGINNING OF CURVE RETURN	ELL	ELBOW	INJ	INJECTOR	PNL	PANEL, PANELBOARD	TPG	TOPPING
BF	BLIND FLANGE	EMBD	EMBEDDED	INS	INSULATE(D)(ION)	POC	POINT OF CURVE	TPLX	TRIPLEXED
BVF	BUTTERFLY VALVE	EMT	ELECTRICAL METALLIC TUBING	INSTR	INSTRUMENTATION	POP	PNEUMATIC OPERATOR	TR	STAIR TREAD
BHP	BRAKE HORSEPOWER	EP	ELECTRIC/PNEUMATIC CONVERTER	INT	INTERIOR	PP	POWER POLE	TRM	TRANSMITTER
BLDG	BUILDING	EPR	EVAPORATOR	INTER	INTERMEDIATE	PRES	PRESSURE	TRN	TRANSDUCER
BLK	BLOCK	EPWWF	EQUALIZED PEAK WET WEATHER FLOW	INV	INVERT	PRD	PRESSURE RELIEF DAMPER	TS	TEMPERATURE SWITCH
BM	BEAM, BENCHMARK	EQ	EQUAL	IT	INSTRUMENT TAP	PRV	PRESSURE REGULATING (REDUCING) VALVE	TSF	TEMPERATURE SWITCH HIGH
BOD	BIOCHEMICAL OXYGEN DEMAND	EQUIP	EQUIPMENT	JB	JUNCTION BOX	PRS	PRESSURE REDUCING STATION	TSL	TEMPERATURE SWITCH LOW
BOT	BOTTOM	ES	EXISTING SURFACE	JST	JOIST	PS	PRESSURE SWITCH, PRESSURE SENSOR	TSR	TERMOSTAT
BSN	BAR SCREEN	EVC	END OF VERTICAL CURVE	JT	JOINT	PSF	POUNDS PER SQUARE FOOT	TV	TERMOSTATIC VALVE
BTU	BRITISH THERMAL UNIT	EW	EACH WAY	K	KIP (1000 POUNDS)	PSIA	POUNDS PER SQUARE INCH ABSOLUTE	TA	TYPICAL
BV	BALL VALVE	EWEF	EACH WAY EACH FACE	KO	KNOCK OUT	PSIG	POUNDS PER SQUARE INCH GAGE	UB	UTILITY BOX
BVC	BEGINNING OF VERTICAL CURVE	EWT	ENTERING WATER TEMPERATURE	KV	KILOVOLT	PSL	PIPE SLEEVE, PRESSURE SWITCH LOW	UH	UNIT HEADER
CAB	DIRECT BURIAL CABLE	EX	EXTRA	KVA	KILOVOLT AMPERE	PSV	POP SAFETY VALVE	UL	ULTIMATE LOAD
CAP	CAPACITY	EXG	EXHAUST GRILLE	KW	KILOWATT	PVC	PLUG VALVE, PROCESS VARIABLE	UN	UNION
CB	CATCH BASIN	EXIST	EXISTING	L	LENGTH	PVL	POLYVINYL CHLORIDE	UG	UNDER GROUND
CC	COOLING COIL	EXP	EXPANSION	LAM	LAMINATED	PVT	PRESSURE VESSEL	UP	UTILITY POLE
C-C	CENTER TO CENTER	EXT	EXTERIOR	LAT	LEAVING AIR TEMPERATURE, LATENT, LATITUDE	Q	RATE OF FLOW	US	UTILITY STATION
CCP	CONCRETE CYLINDER PIPE	EWT & B	EACH WAY, TOP AND BOTTOM	LB	POUND	QCPLG	QUICK COUPLING	VB	VARIABLE
CCSP	CONCRETE LINED AND COATED STEEL PIPE	F	FAHRENHEIT, FACE, FUSE(D), FAN	LEV	LEVEL	R	RADIUS, RISER	VAC	VOLTS AC/DC
CD	CEILING DIFFUSER	FAB	FABRICATE(D)(TION)	LOS	LOCKOUT STOP	R/C	REINFORCED CONCRETE	VAR	VOLTS AC/DC
CDR	CONDUCCTOR, CONDENSER	FAI	FRESH AIR INTAKE	LP	LOW PRESSURE, LIGHTING PANEL	RA	RETURN AIR	VB	VARIABLE
CDU	CONDENSING UNIT	FB	FLAT BAR, FLOOR BEAM	LS	LEVEL SWITCH	RAF	ROLL TYPE AIR FILTER	VCP	VERTICAL CURVE
CED	CEILING EXHAUST DIFFUSER	FC	FAIL CLOSED	LSH	LEVEL SWITCH HIGH	RCDR	RECORDER	VD	VOLUME DAMPER
CER	CEILING EXHAUST REGISTER	FCO	FLOOR CLEANOUT	LSL	LEVEL SWITCH LOW	RCP	REINFORCED CONCRETE PIPE	VDC	VOLTS DIRECT CURRENT
CF	CUBIC FEET	FCR	FINE CRUSHED ROCK	LTG	LIGHTING	RD	ROOF DRAIN	VERT	VERTICAL
CFH	CUBIC FEET PER HOUR	FD	FLOOR DRAIN, FIRE DAMPER	LWR	LOWER	RDWY	ROADWAY	VF	VARIABLE FREQUENCY CONTROLLER
CFM	CUBIC FEET PER MINUTE	FE	FLOWMETER	MAN	MANUAL(LY)	REC	RECEIVER	VAC	VOLTS AC/DC
CFR	CODE OF FEDERAL REGULATIONS	FF	FAR FACE	MAX	MAXIMUM	RECD	RECEIVED	VAR	VOLTS AC/DC
CFS	CUBIC FEET PER SECOND	F-F	FACE TO FACE	MABH	THOUSAND BTU'S PER HOUR	RECP	RECEPTACLE	VCR	VARIABLE
CHR	CHILLER	FG	FLAP GATE	MCC	MOTOR CONTROL CENTER	RED	REDUCE(R)	VD	VOLTS DIRECT CURRENT
CI	CAST IRON	FH	FIRE HYDRANT, FLATHEAD	MD	MOTORIZED DAMPER	REG	REGULATOR	VRT	VERTICAL
CIP	CAST IRON PIPE	FHD	FLATHEAD	MEE	MISCELLANEOUS ELECTRICAL EQUIPMENT	REINF	REINFORCE, REINFORCING	WP	WATER
CIRC	CIRCUMFERENCE	FIN	FINISHED	MFR	MISCELLANEOUS METAL HOSE	REL	RELAY	WC	WATER COLUMN
CJ	CONSTRUCTION JOINT	FL	FLOW LINE	MGD	MILLION GALLONS PER DAY	REM	REMOVE, REMOVABLE	WCA	WATER COLUMN
CKPL	CHECKER PLATE	FLEX	FLEXIBLE	MG/L	MILLIGRAMS PER LITER	REQ'D	REQUIRED	WE	WALL CLEANOUT
CL	CLEARANCE	FLG	FLANGE(D)	MIE	MISCELLANEOUS INSTRUMENTATION EQUIPMENT	RGS	RIGID GALVANIZED STEEL	WE	WOOD
CLR	CLAR, CHLORINATOR	FLP	FLUID POWER UNIT	MIL SPEC	MILITARY SPECIFICATION	RM	ROOM	WEF	WALL EXHAUST GRILLE
CL2	CHLORINE	FLR	FLOOR	MIN	MINIMUM, MINUTE	RPM	REVOLUTIONS PER MINUTE	WEF	WALL EXHAUST REGISTER
CM	MANUAL CONTROL STATION	FLT	FILTER	MISC	MISCELLANEOUS	RR	RAILROAD	WF	WIDE FLANGE
CMA	MANUAL AUTO CONTROL STATION	FM	FORCE MAIN	MJD	MILLION JOURNEY MILES	RT	RIGHT	WI	WROUGHT IRON
CMC	CEMENT MORTAR COATED	FMH	FLEXIBLE METAL HOSE	MME	MISCELLANEOUS MECHANICAL EQUIPMENT	RTP	REINFORCED THERMOSET POLYESTER	W/O	WITHOUT
CML	CEMENT MOTOR LINER	FO	FAIL OPEN	MOP	MOTOR OPERATOR	RTU	REMOTE TERMINAL UNIT	WS	WATER SURFACE
CMP	CORRUGATED METAL PIPE	FPC-T	FLEXIBLE PIPE COUPLING	MTR, M	MOTOR	RWL	REDUCED LEVEL	WSR	WALL SUPPLY REGISTER
CMP-AC	CORRUGATED METAL PIPE ASPHALT COATED	FPC-T	FLEXIBLE PIPE COUPLING TO TAKE TENSION	MUL/DIV	MUL/TIVE/DIVIDE	RWP	RAINWATER LEADER	WSTP	WATERSTOP
CNTL	CONTROL	FPM	FEET PER MINUTE	MV	MUD VALVE, MILLIVOLT	S	SOUTH, SILENCER	WT	WATERTIGHT
CO	CLEANOUT	FPS	FEET PER SECOND	MVU	MOBILE VENTILATION UNIT	SB	SIGNAL BOX	WFF	WELDED WIRE FABRIC
CO2	CARRON DIOXIDE	FRP	FIBERGLASS REINFORCED PIPE	MX	MIXER	SCH	SCHEDULE	XCON	SPARE CONDUIT
COD	CHEMICAL OXYGEN DEMAND	FRS	FREEZESTAT	N	NEUTRAL, NORTH	SCR	SCRUBBER	XFMR	TRANSFORMER
COL	COOLING AIR	FS	FLOW SWITCH, FAR SIDE	NA	NONAUTOMATIC	SD	SPLITTER DAMPER, SMOKE DETECTOR	XGP	CROSS LINKED POLYETHYLENE
COM	COLUMN	FSH	FLOW SWITCH HIGH	NAOH	SODIUM HYDROXIDE	SEP	SEPARATOR	XLR	EXPLOSION PROOF
CONC	COMMUNICATOR	FSL	FACULTATIVE SLUDGE LAGOON, FLOW SWITCH LOW	NC	NORMALLY CLOSED	SG	SUPPLY GRILLE, SLUICE GATE-MANUAL	XSW	TRANSFER SWITCH
COND	CONCRETE	FT	FEET	NEG	NEGATIVE	SHT	SHOOT	ZS	POSITION SWITCH, (LIMIT) SWITCH
CONN	CONDUCTIVITY, CONDUCTOR, CONDENSATE	FTG	FOOTING	NIC	NOT IN CONTRACT	SI	SPEED INCREASE	NOTES	
CONT	CONTINUED(DOUS)	FTGS	FITTINGS	NO	NORMALLY OPEN NUMBER	SIM	SIMILAR	1.	ADDITIONAL ABBREVIATIONS ARE DEFINED IN ANSI Y1.1-1972.
CP	COMPRESSOR	FUT	FUTURE	NOX	NITRATES AND NITRITES	SL	SLICE	2.	FOR ELECTRICAL ABBREVIATIONS SEE DWG E1.
CPLG	COUPLING	FZT	FREEZESTAT	NPSH	NET POSITIVE SUCTION HEAD	SLG	SLIDE GATE	3.	STANDARD ABBREVIATIONS ARE FOR REFERENCE ONLY. NOT ALL ABBREVIATIONS ARE USED IN THESE CONTRACT DRAWINGS.
CPVC	CHLORINATED POLYVINYL CHLORIDE	G	POWER ACTUATED GATE	NRS	NONRISING STEM	SN	SCREEN		
CR	CONTROL RELAY	GA	GAGE	NS	NEAR SIDE	SP	SPACE, SET POINT, STATIC PRESSURE, STOP		
CRF	CHEMICAL FEEDER	GALV	GALVANIZED	NTS	NOT TO SCALE	SPEC	SPECIFICATION(S)		
CRN	CRANE	GB	GRADE BREAK	OA	OUTSIDE AIR, OVERALL	SPG	SPACING		
CREJ	CORRUGATED RUBBER EXPANSION JOINT	GBV	GLOBE VALVE	OAI	OUTSIDE AIR INTAKE	SO2	SULFUR DIOXIDE		
CSD	CEILING SUPPLY DIFFUSER	GD	GUARD	OC	ON CENTER	SPL	SPlice		
CTF	CENTRIFUGE	GDR	GRINDER			SQ	SQUARE		
CTR	CONTRACTOR, CENTER	GEN	GENERAL, GENERATOR			SR	SPEED REDUCER		
CU	CONTROL UNIT, COPPER, CUEIC	GL	GLASS		</				

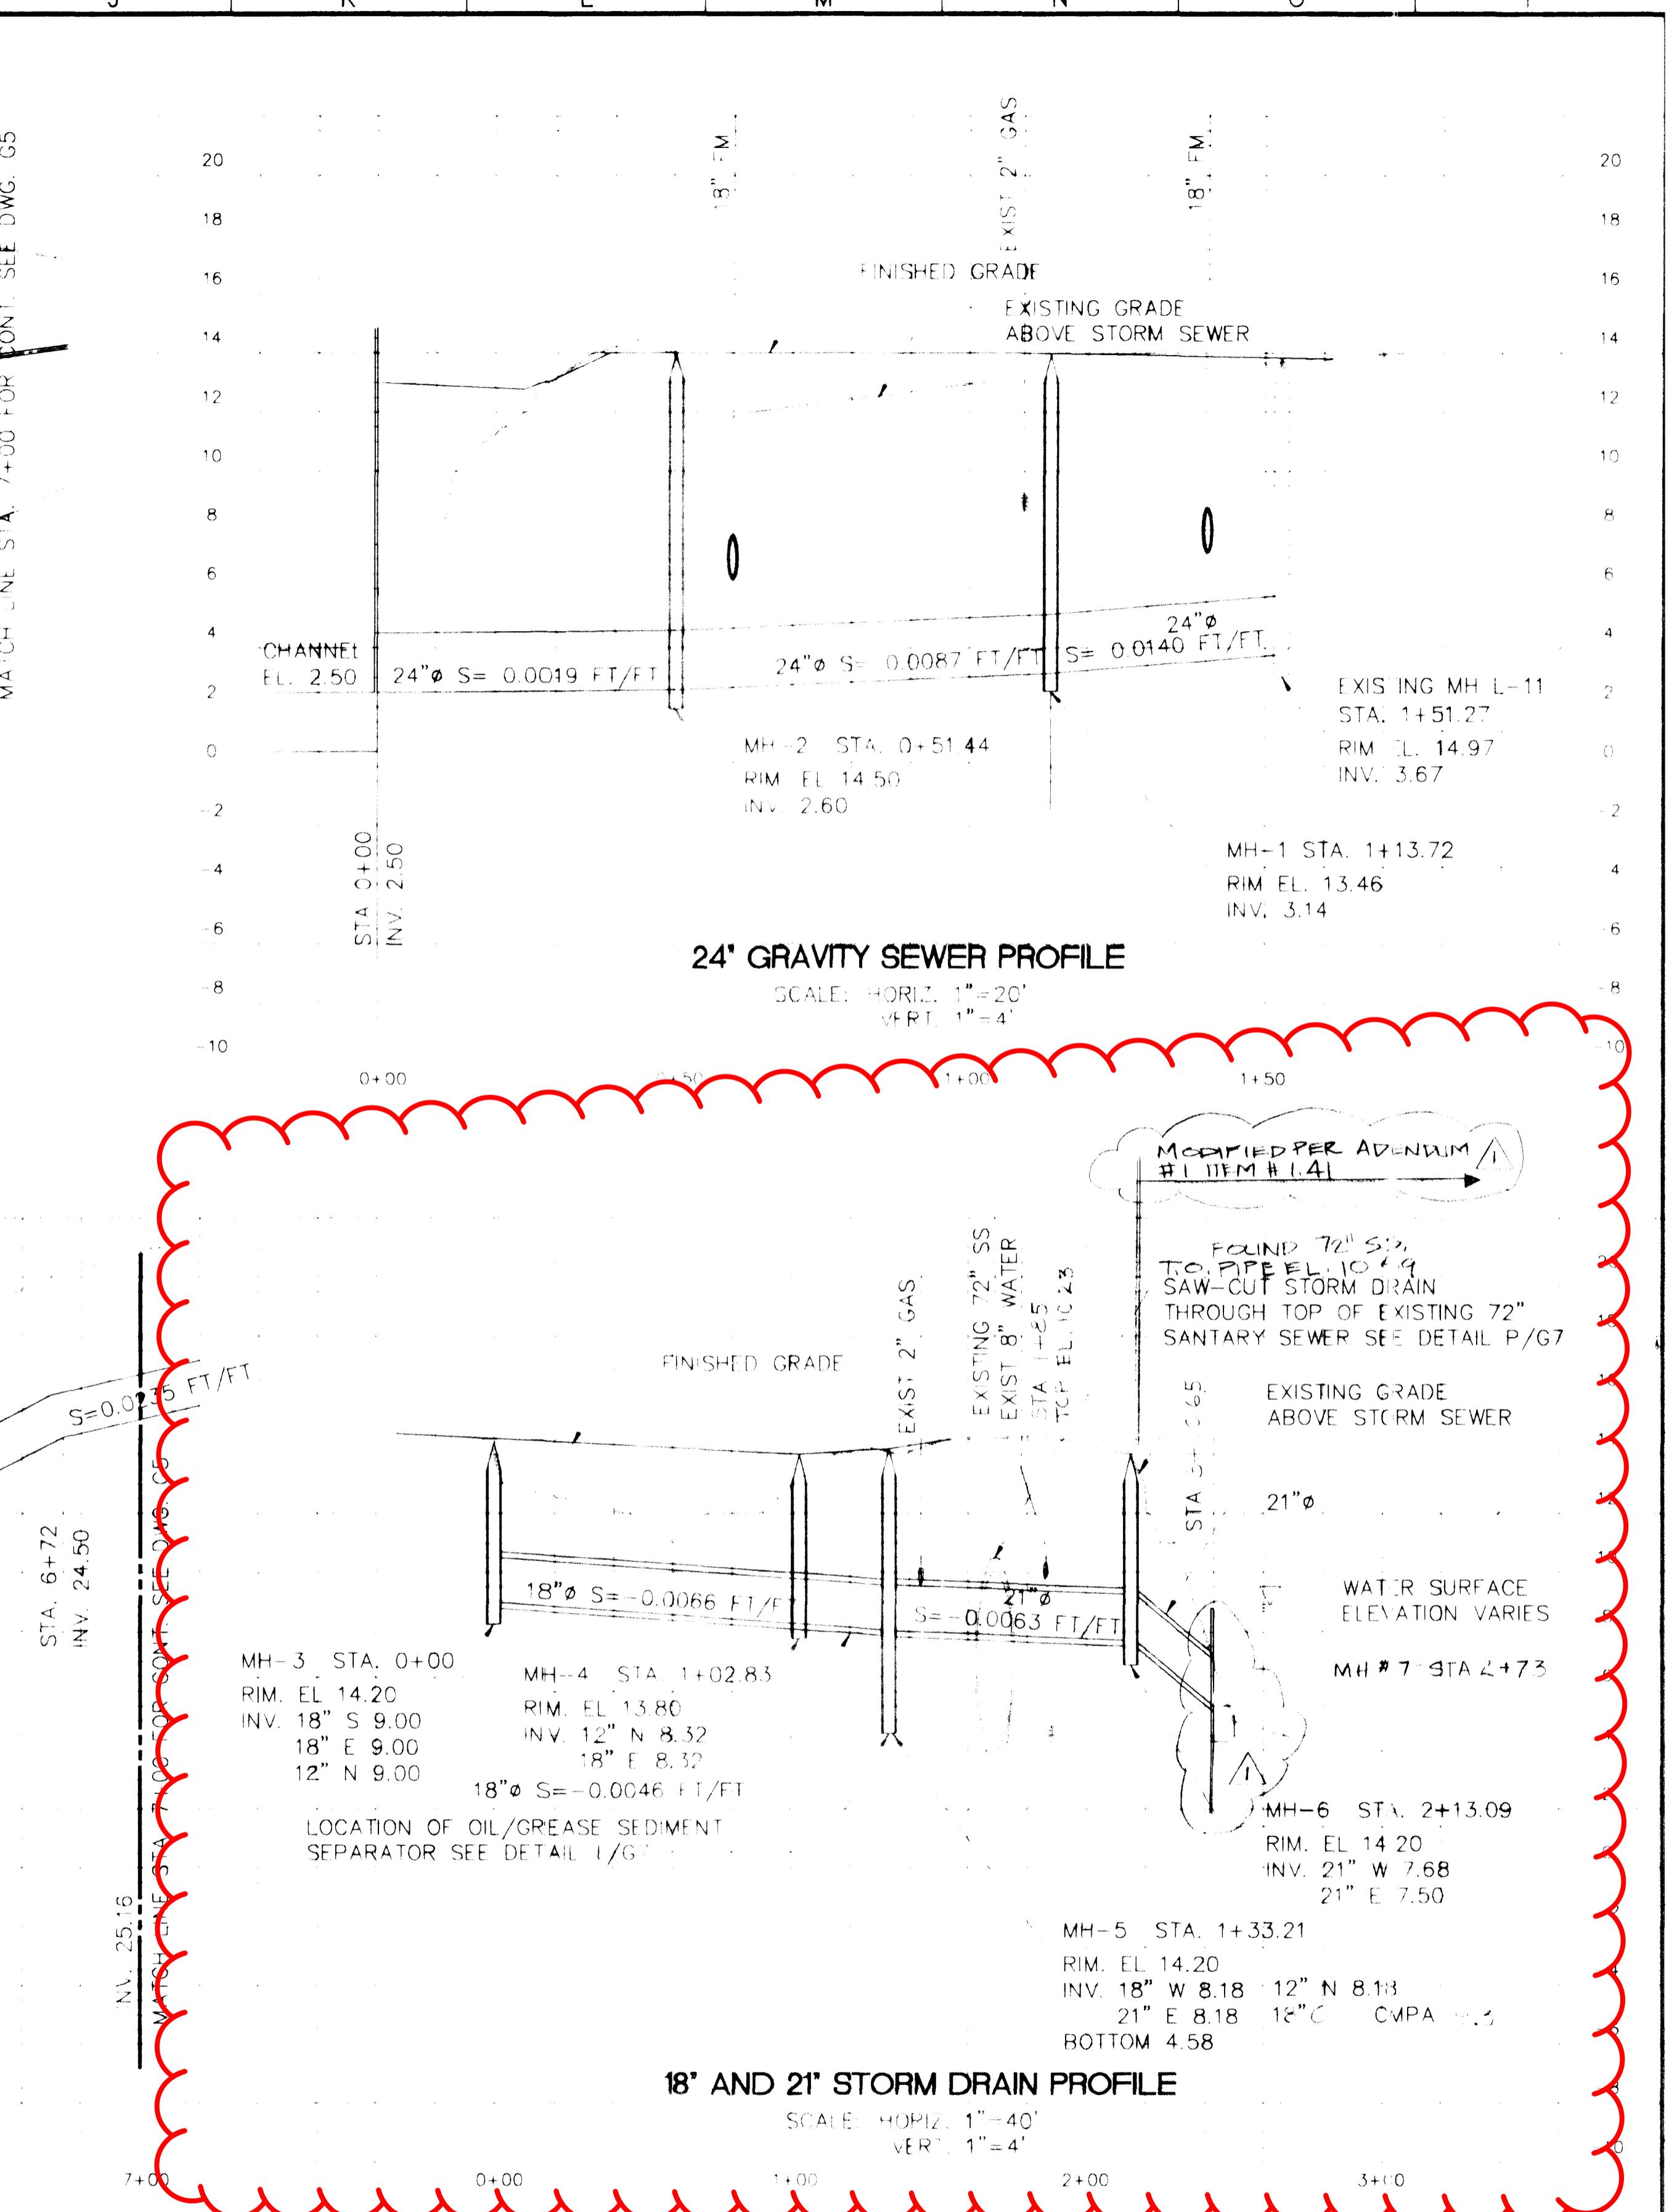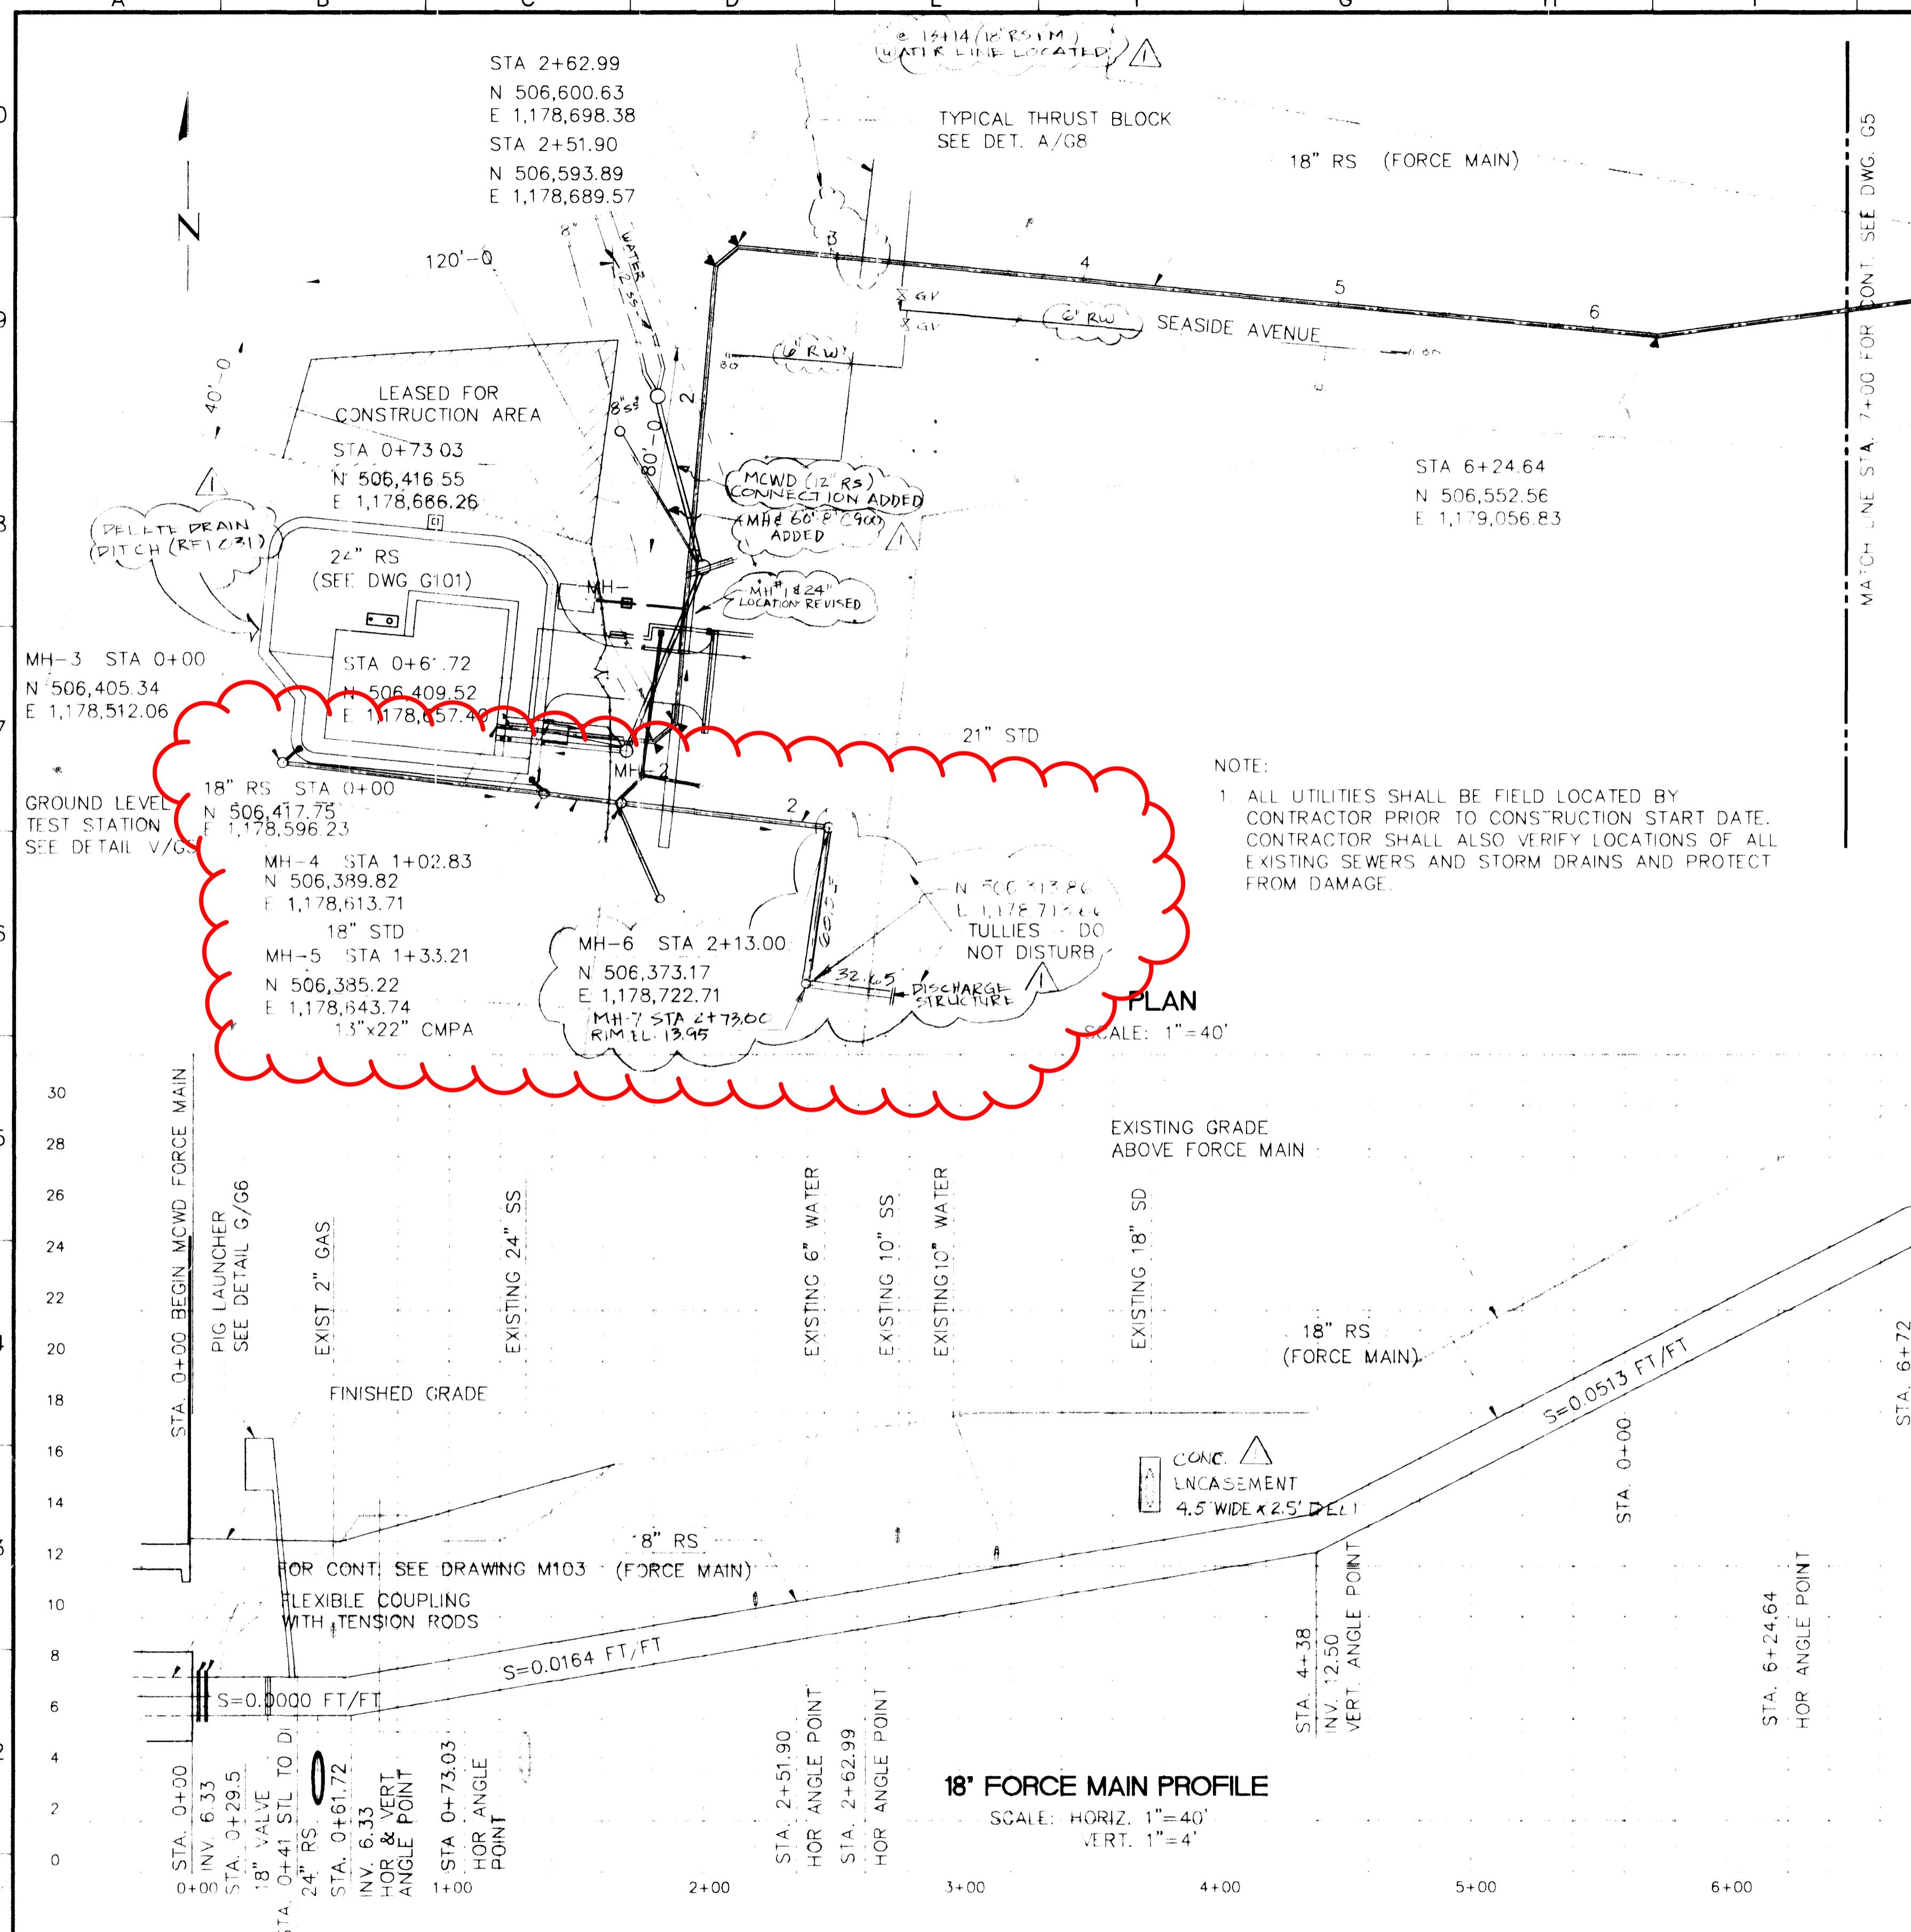

B C Brown and Caldwell Consultants

LINE IS 2 INCHES
AT FULL SIZE
(IF NOT 2"-SCALE ACCORDINGLY)


FILE _____

DRAWN _____

DESIGNED _____

CHECKED _____

CHECKED _____

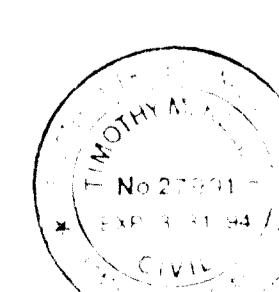


MCWD CONNECTION FACILITIES

MONTEREY REGIONAL
WATER POLLUTION CONTROL AGENCY
MONTEREY COUNTY, CALIFORNIA


PLAN AND PROFILE 1

SCALE	1:100
DRAWING NUMBER	G4
SHEET NUMBER	1

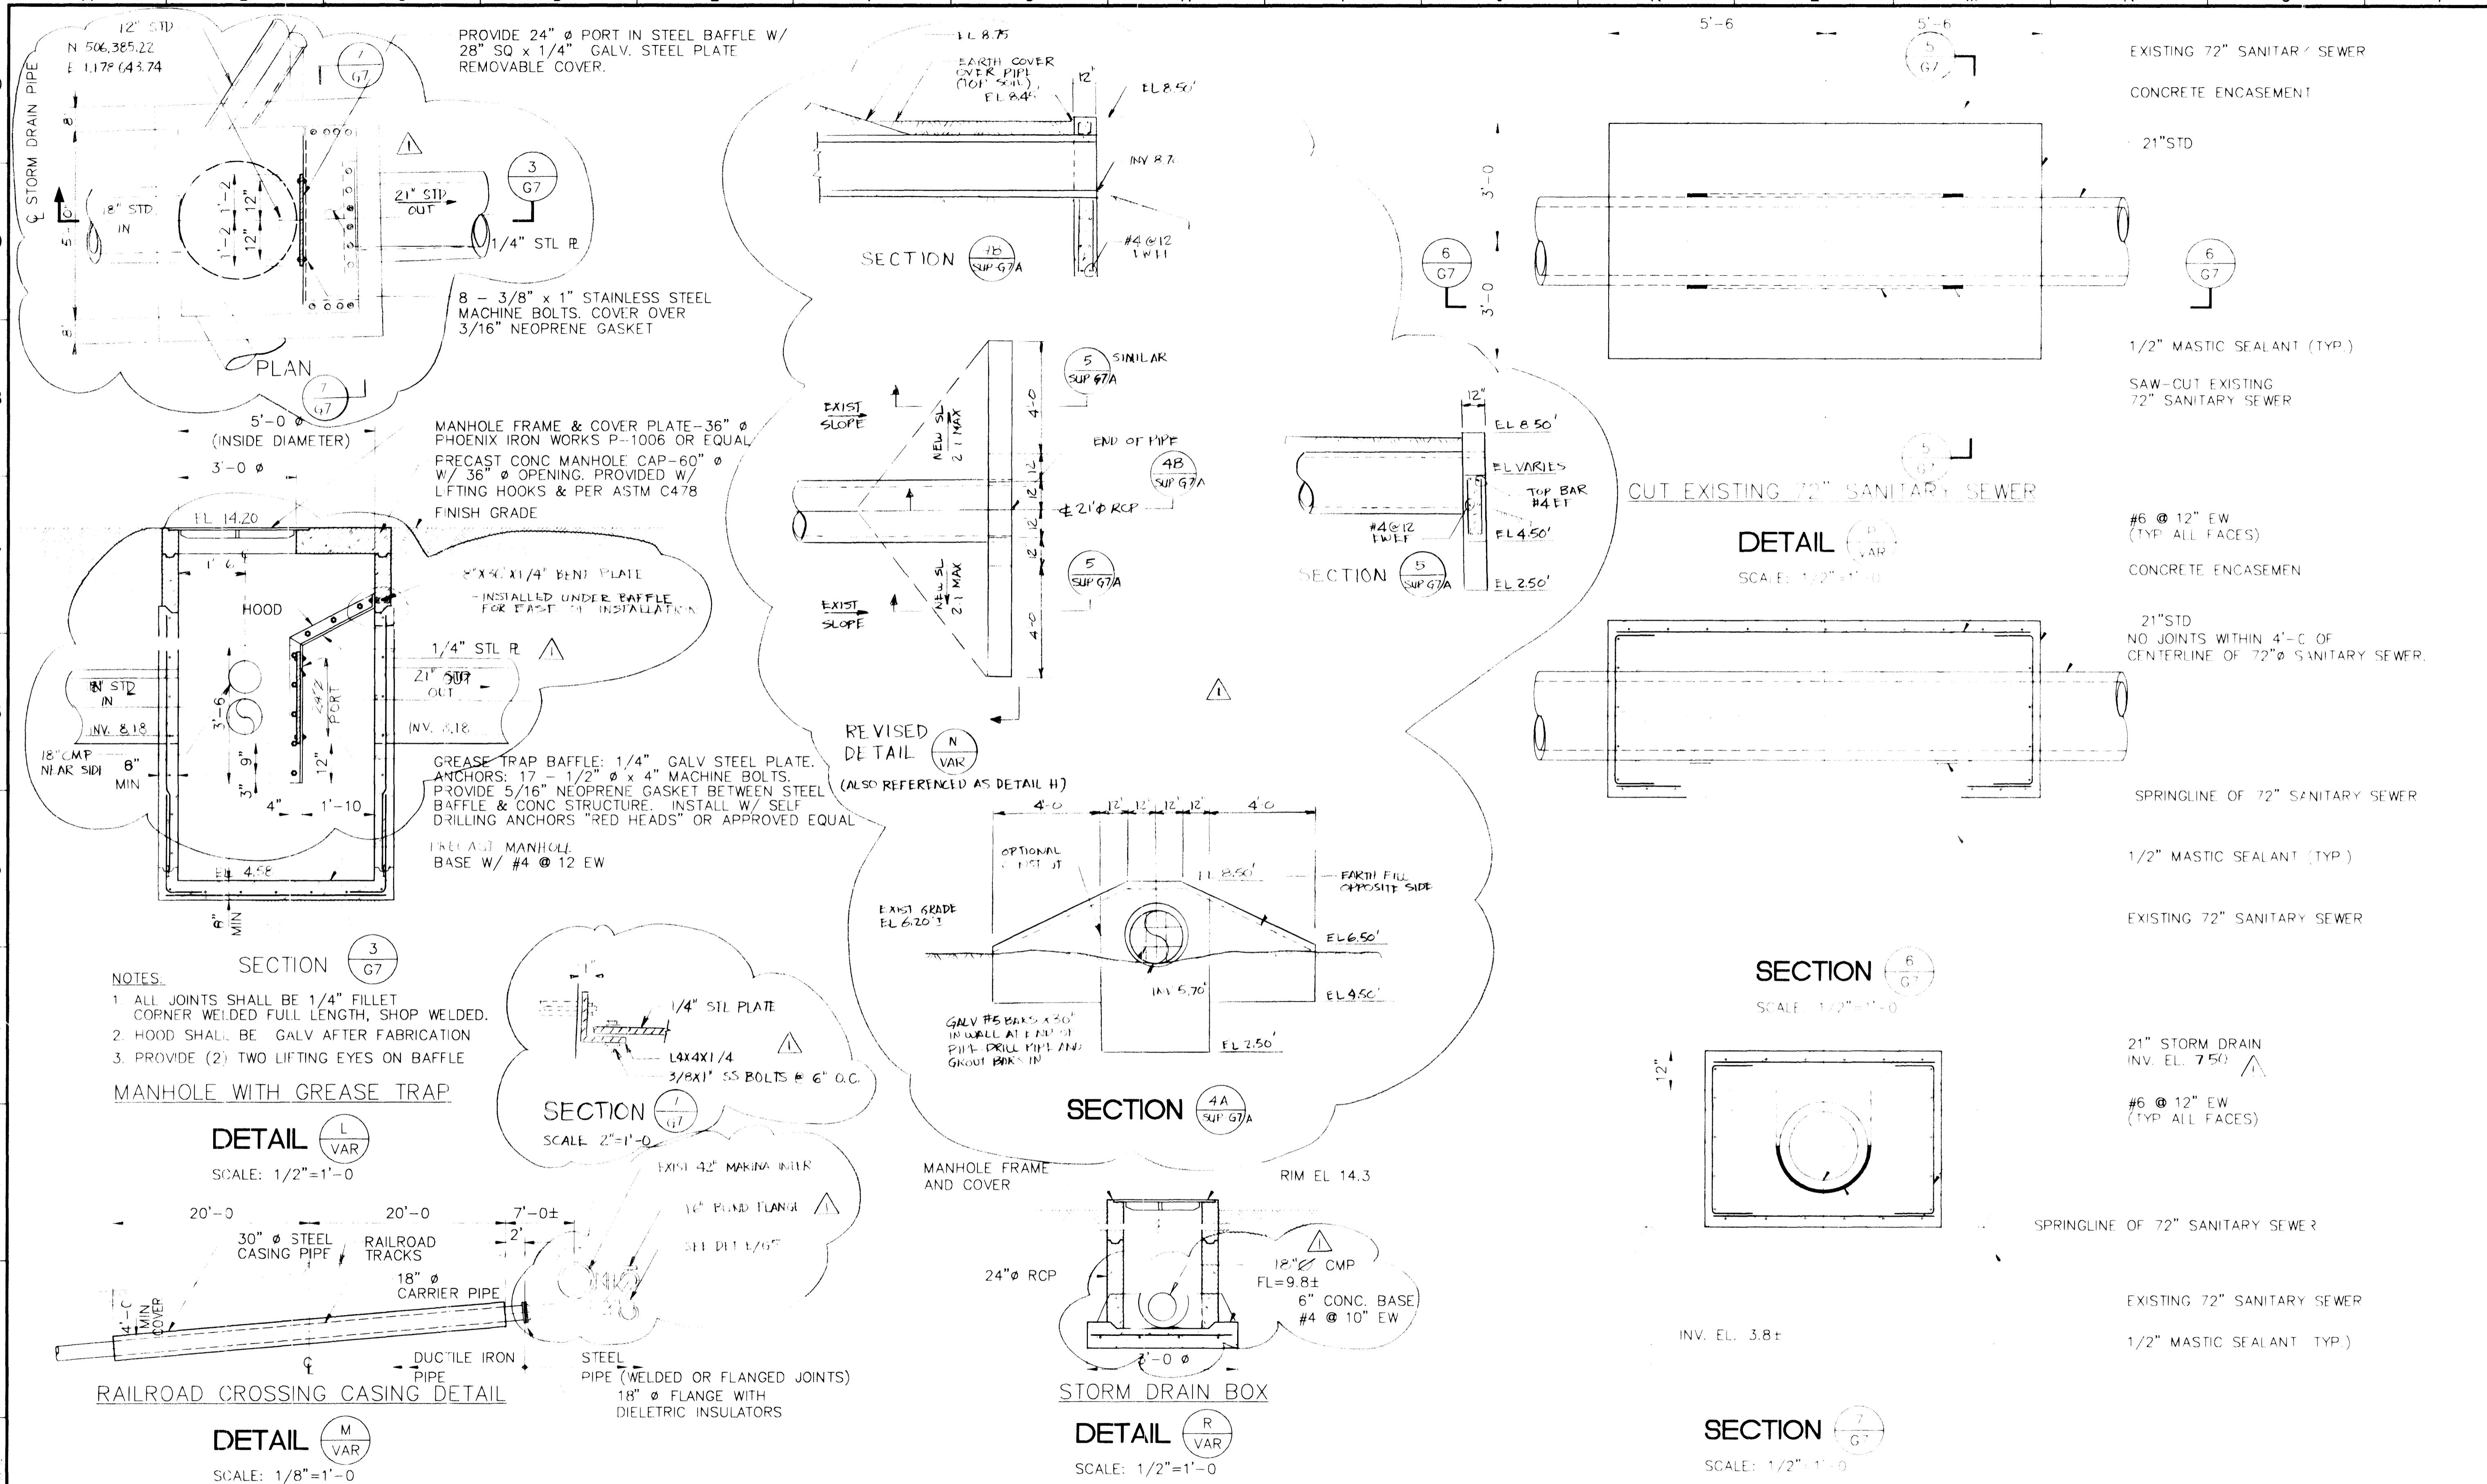

BC Brown and Caldwell Consultants

SUBMITTED: Mrs. M. Miller DATE: 1-14-92
PROJECT MANAGER
APPROVED: Joseph Allen DATE: 1-14-92
BROWN AND CALDWELL
APPROVED: DATE:

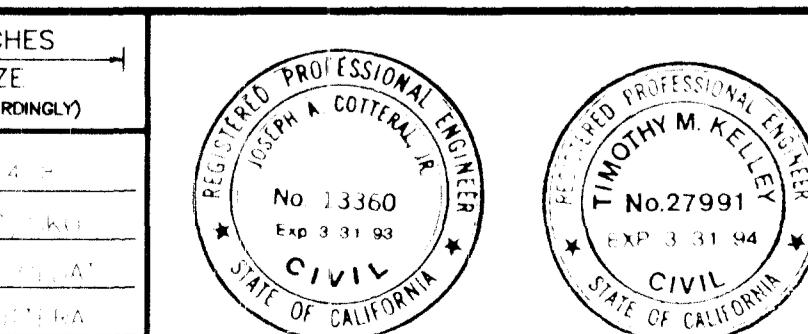


MCWD CONNECTION FACILITIES


**MONTEREY REGIONAL
WATER POLLUTION CONTROL AGENCY
MONTEREY COUNTY, CALIFORNIA**

MISCELLANEOUS DETAILS 2

SCALE	
1/2" = 1'-0"	
A-A	
DRAWING NUMBER	
G7	
SHEET NUMBER	

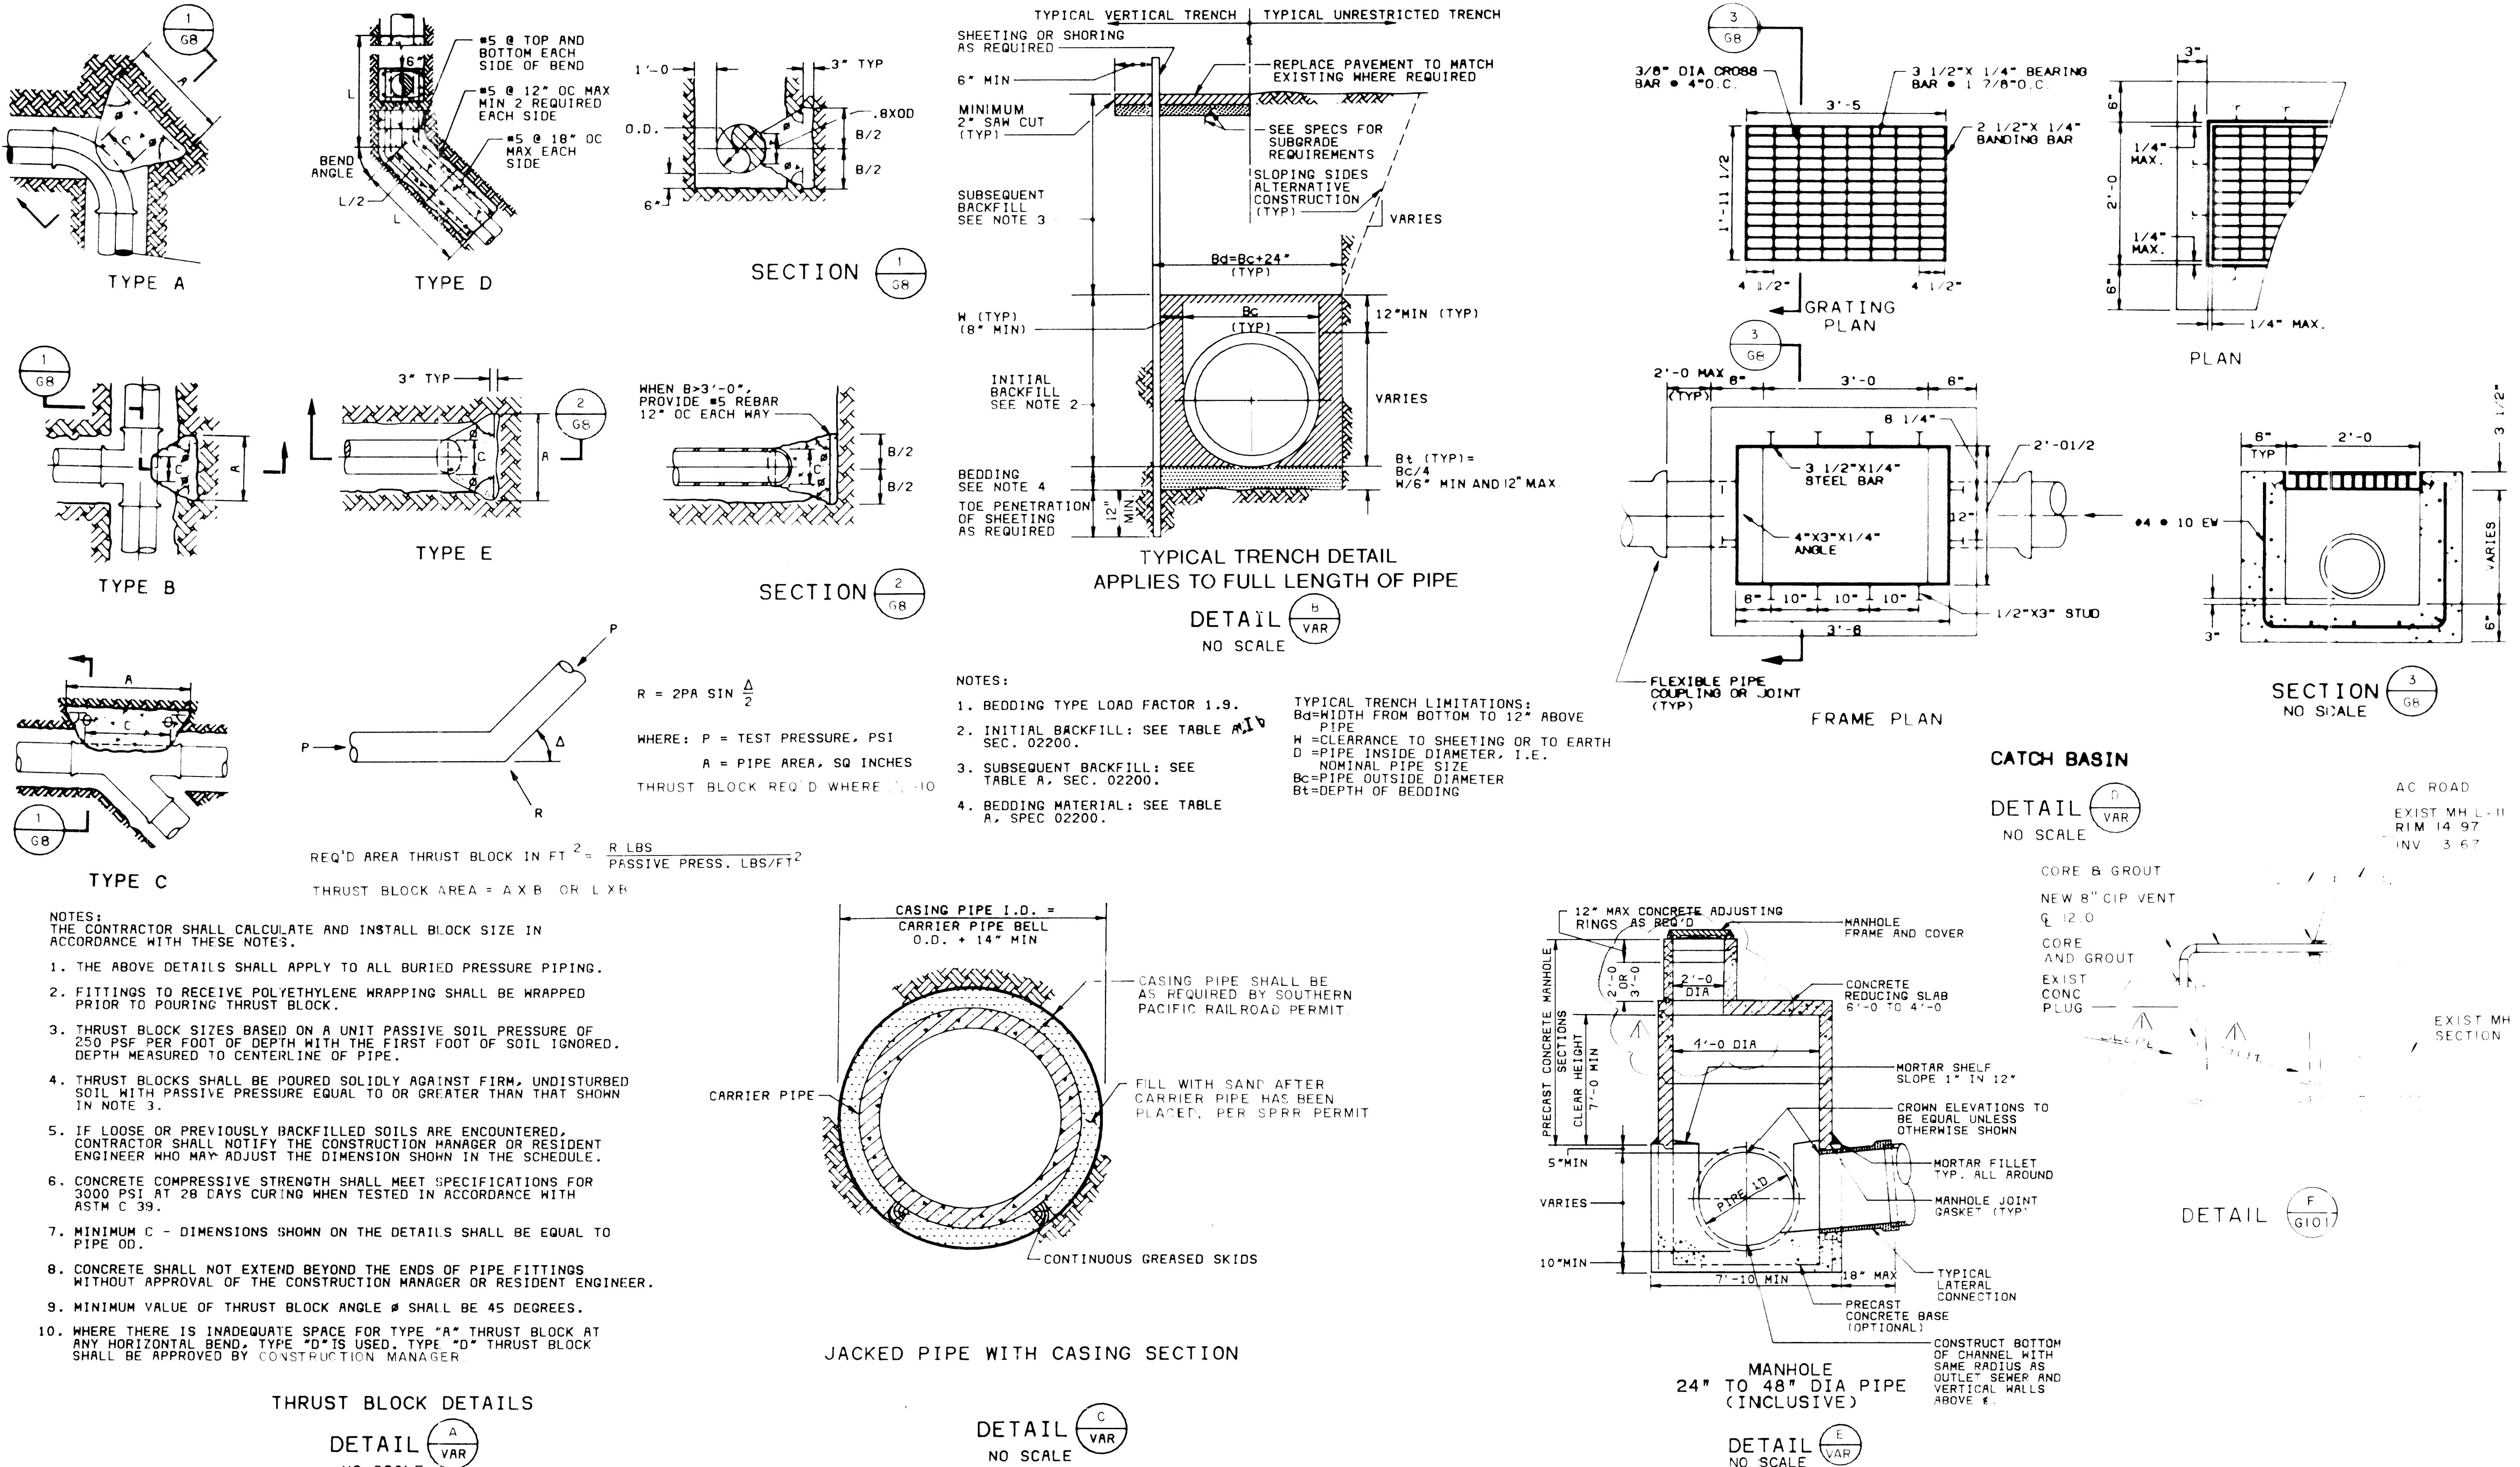

BC Brown and Caldwell Consultants		LINE IS 2 INCHES AT FULL SIZE (IF NOT, USE ALL DRAWINGS)	FILE 5478 DRAWN C TO DESIGNED M MOAYER CHECKED CHECKED	ZONE REV DATE 1-14-94 REVISIONS DESCRIPTION BY DATE APP KT	MCWD CONNECTION FACILITIES MONTEREY REGIONAL WATER POLLUTION CONTROL AGENCY MONTEREY COUNTY, CALIFORNIA	GENERAL	SCALE NO SCALE DRAWING NUMBER G8 SHEET NUMBER D
14273	Project Manager: [Signature] Approved: [Signature]	Date: 1-14-94	File No. 5478 Drawing No. 13360 Expi. 3-3-94 State of California Civil Engineering	Rev. A Date: 1-14-94 Description: CURE & CORRECTION	By Date App KT	MISCELLANEOUS DETAILS 3	

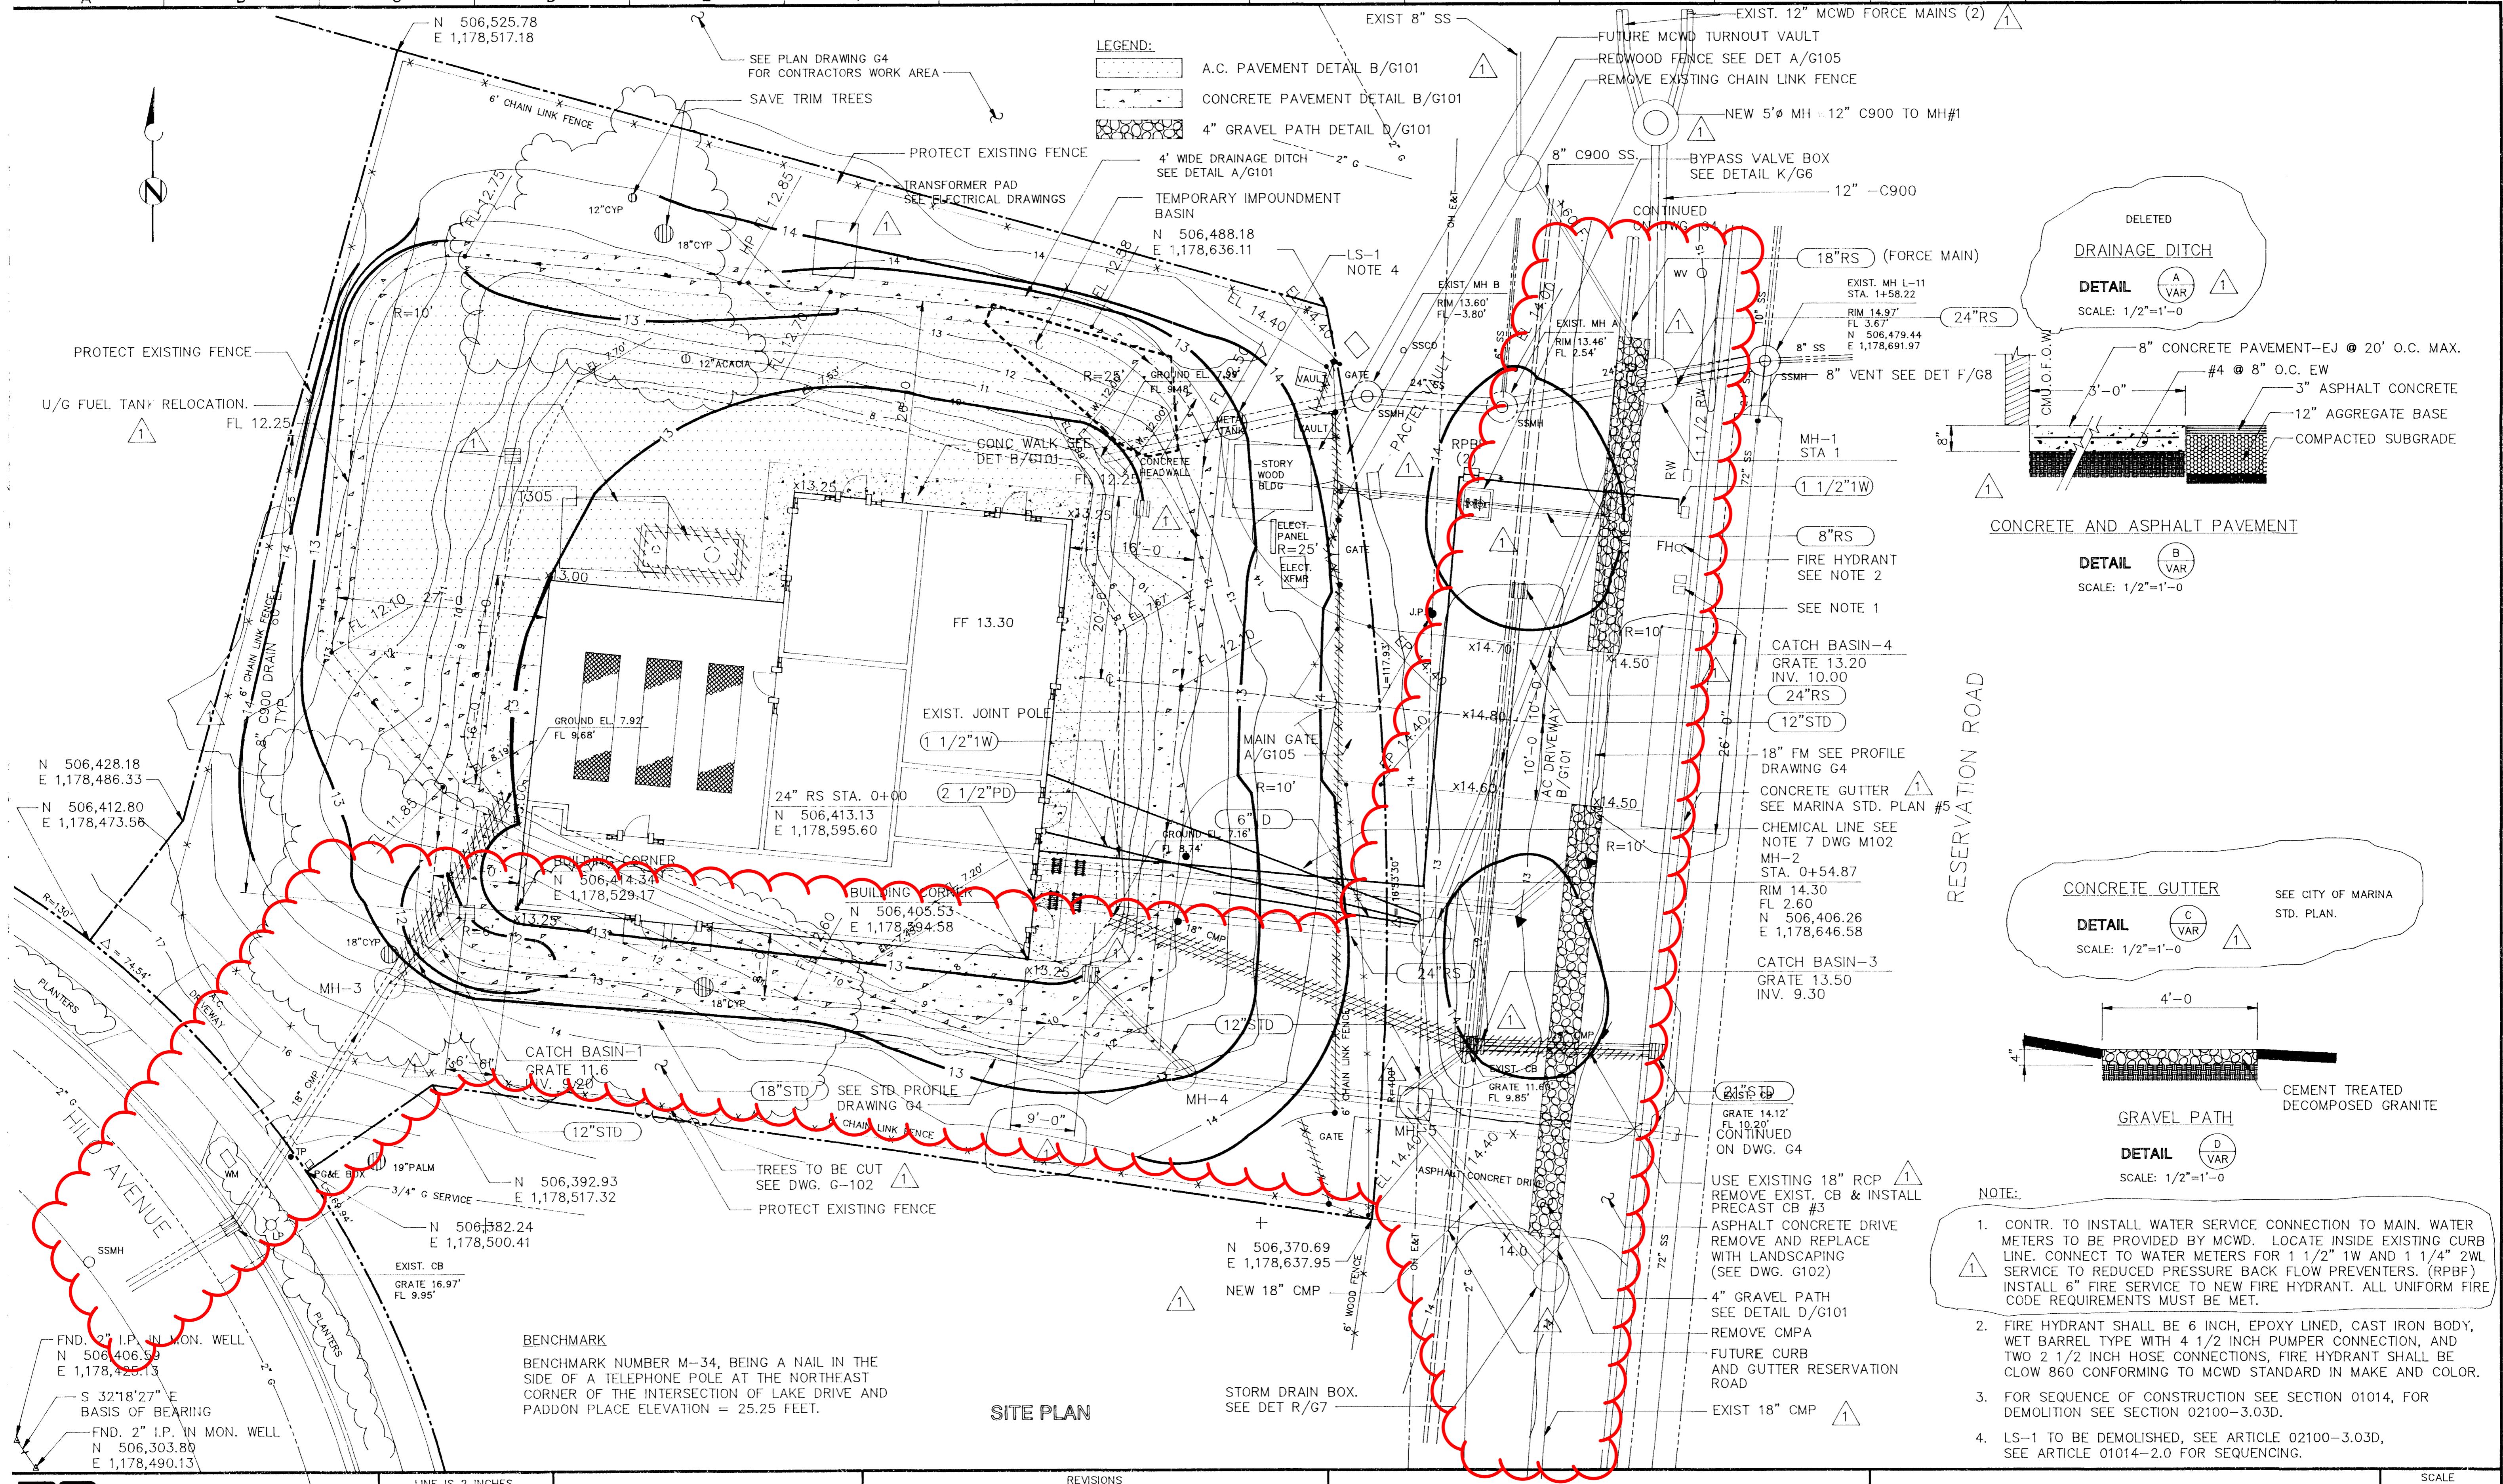

CONTR. TO INSTALL WATER SERVICE CONNECTION TO MAIN. WATER METERS TO BE PROVIDED BY MCWD. LOCATE INSIDE EXISTING CURB LINE. CONNECT TO WATER METERS FOR 1 1/2" 1W AND 1 1/4" 2WL SERVICE TO REDUCED PRESSURE BACK FLOW PREVENTERS. (RPBF) INSTALL 6" FIRE SERVICE TO NEW FIRE HYDRANT. ALL UNIFORM FIRE CODE REQUIREMENTS MUST BE MET.

FIRE HYDRANT SHALL BE 6 INCH, EPOXY LINED, CAST IRON BODY, SET BARREL TYPE WITH 4 1/2 INCH PUMPER CONNECTION, AND TWO 2 1/2 INCH HOSE CONNECTIONS, FIRE HYDRANT SHALL BE

FOR SEQUENCE OF CONSTRUCTION SEE SECTION 01014, FOR
DEMOLITION SEE SECTION 02100, 3-03D.


S-1 TO BE DEMOLISHED, SEE ARTICLE 02100-3.03D,
SEE ARTICLE 01014-2.0 FOR SEQUENCING.

GENERAL SCALE

$1^{\circ} = 10'$

SITE PLAN C101

SHEET NUMBER

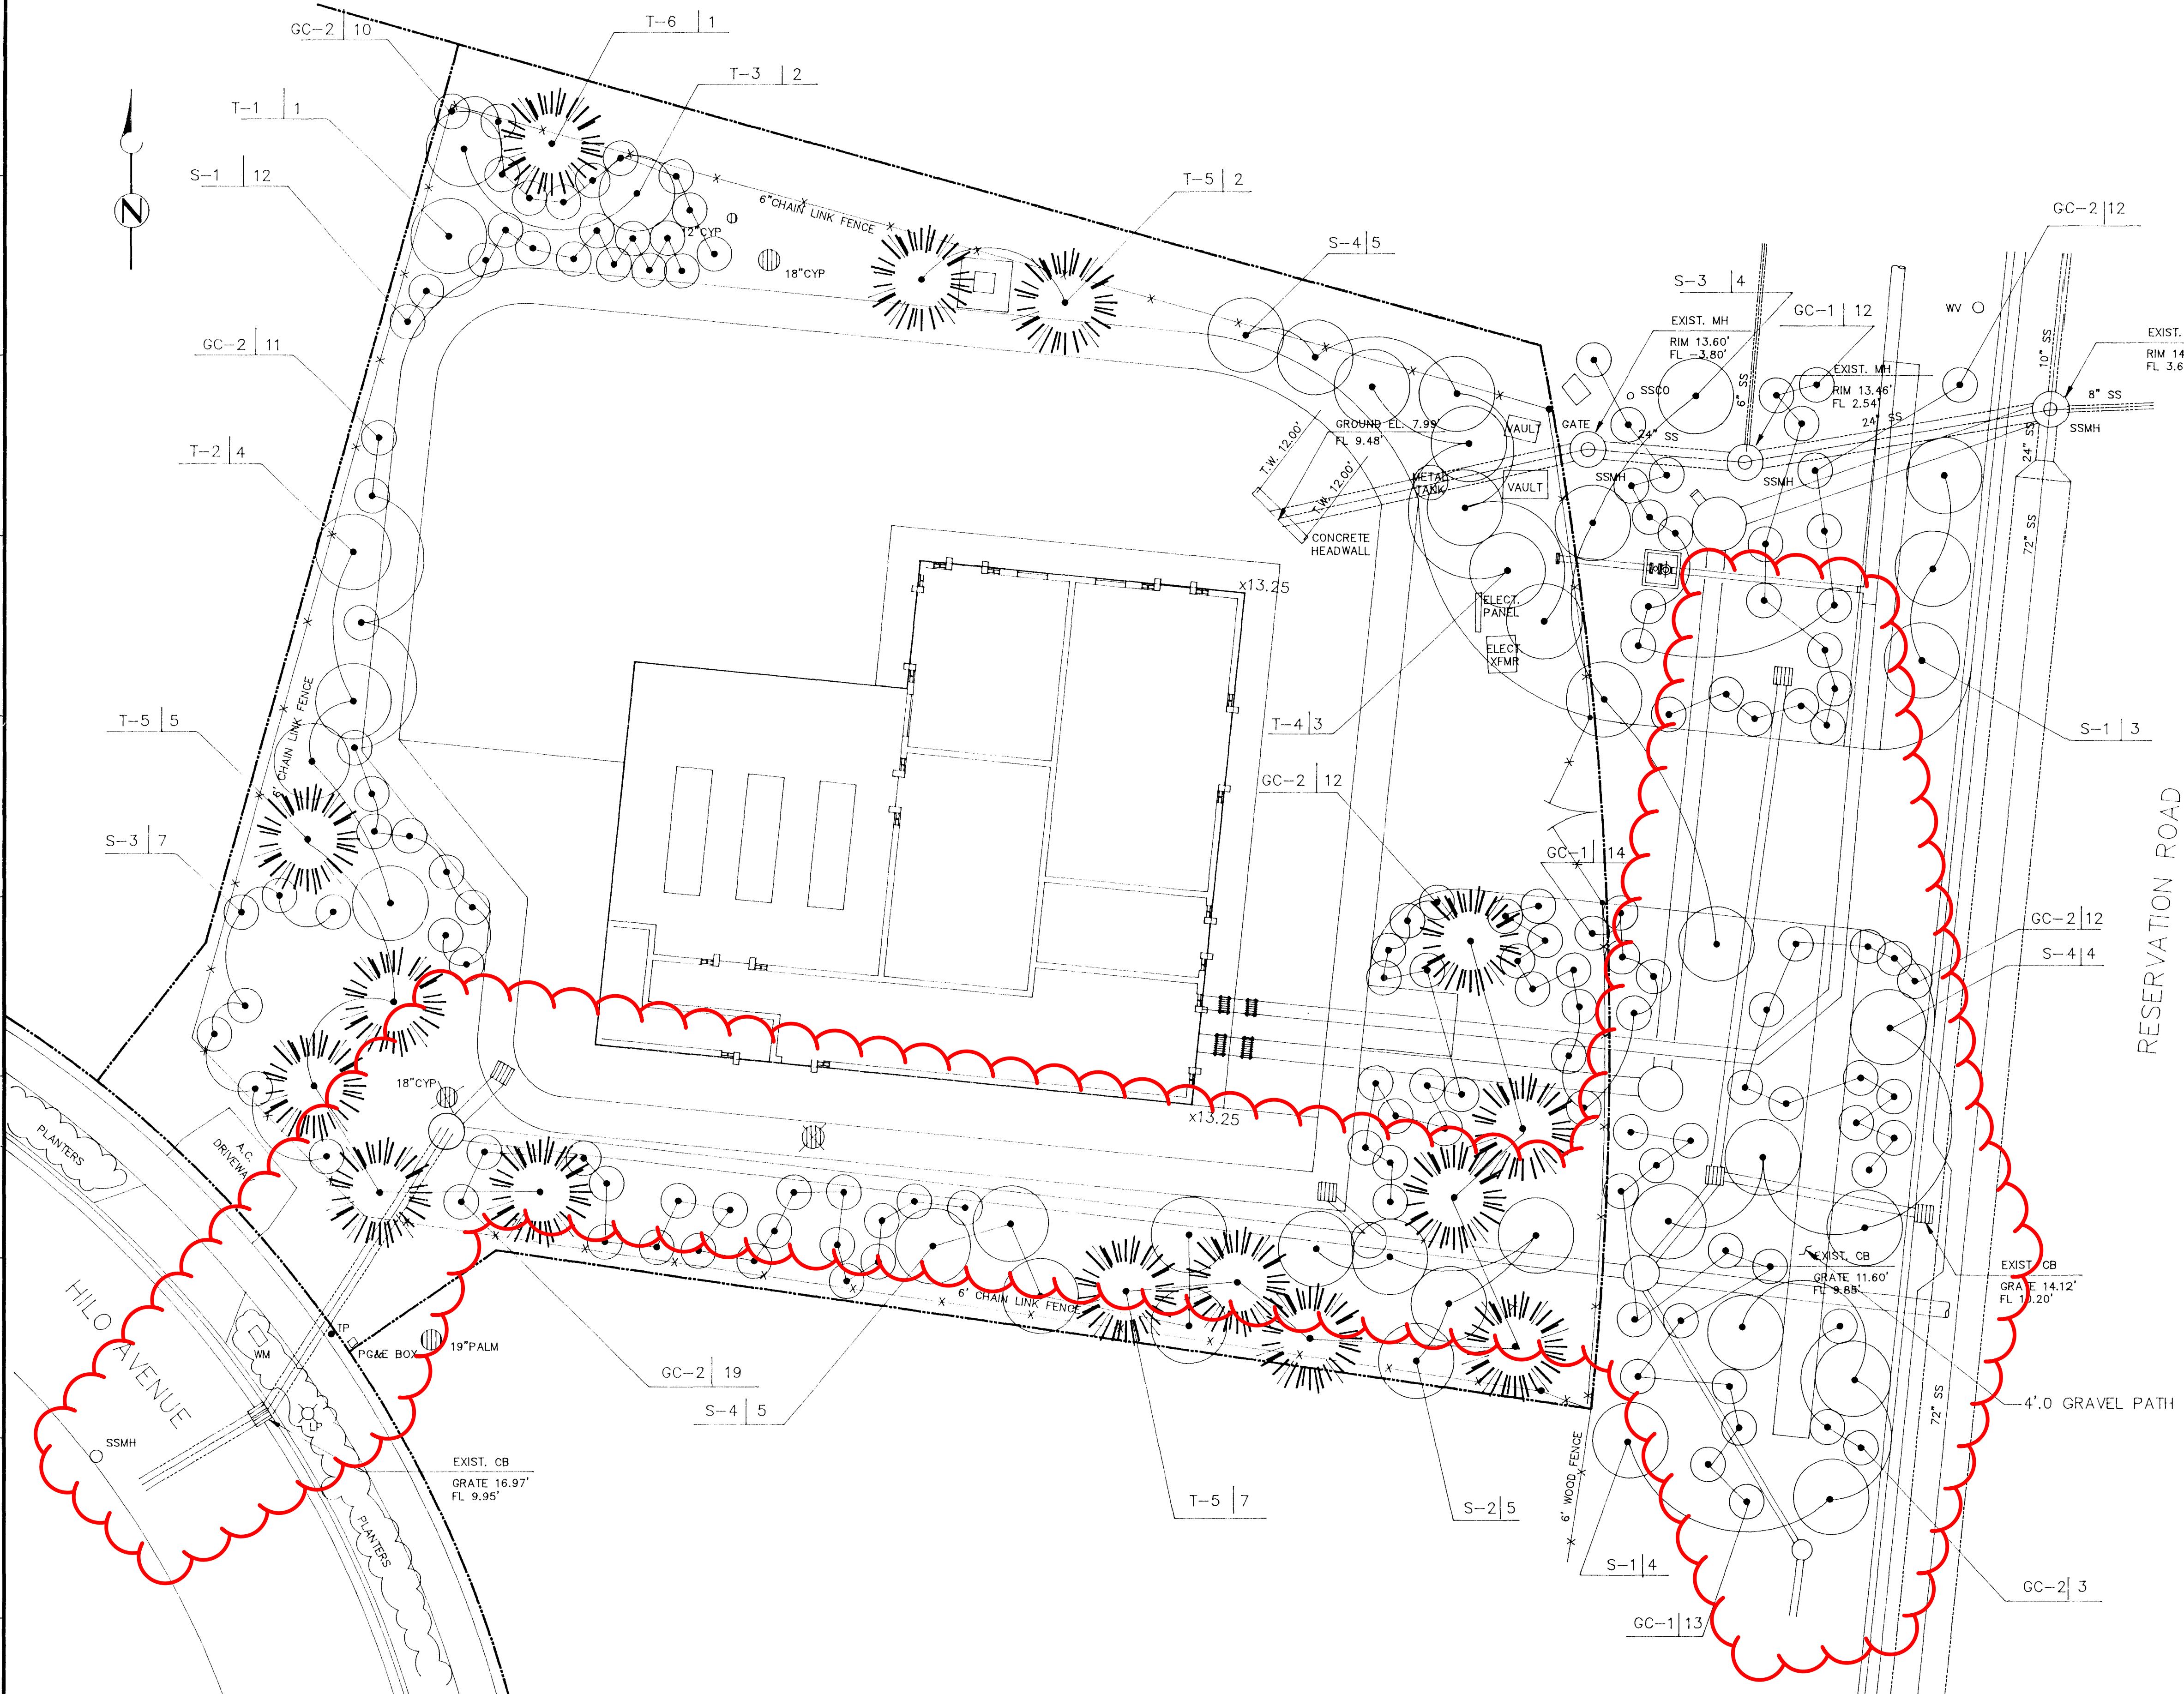

ITEM.	QUANTITY	BOTANICAL NAME	COMMON NAME	SIZE
T-1	1	ACACIA BAILEYANA		5 GAL.
T-2	4	ACACIA CRASPEDOCARPA		5 GAL.
T-3	2	ACACIA DECORA		5 GAL.
T-4	3	CEANOOTHUS "RAY HARTMAN"		5 GAL.
T-5	14	CUPRESSUS MACROCARPA	MONTEREY CYPRESS	5 GAL.
T-6	1	PINUS CANARIENSIS	CANARY ISLAND PINE	5 GAL.

SHRUBS				
S-1	19	ARCTOSTAPHYLOS HOOKERI "MONTEREY CARPET"	MANZANITA	1 GAL.
S-2	5	CEANOOTHUS "CONCHA"		1 GAL.
S-3	11	CEANOOTHUS "DARK STAR"		1 GAL.
S-4	14	FREMONTODENDRON CALIFORNICUM "CALIFORNIA GLORY"		1 GAL.

ROUND COVER


GC-1 39	CEANOTHUS GLORIOSUS "ANCHOR BAY"	1 GAL.
GC-2 79	CEANOTHUS HORIZONTALIS "YANKEE POINT"	1 GAL.

LEGEND

- TREE TO REMAIN (CONTRACTOR TO PROTECT FROM DAMAGE & TRIM AS NECESSARY) 
 - TREE TO BE REMOVED
 - BROADLEAF TREE OR SHRUB
 - CONIFEROUS TREE OR SHRUB
 - GROUND COVER

PLANT NUMBER

T-1 | 3

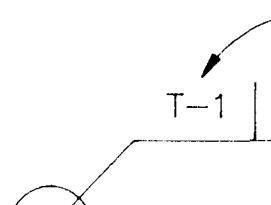

The logo consists of the letters 'BC' in a large, bold, black font. Below the letters is a stylized graphic element resembling a wavy line or a series of horizontal bars.

Brown and Caldwell
Consultants

SUBMITTED: _____
PROJECT MANAGER
APPROVED: _____
BROWN AND CALDWELL

LINE IS 2 INCHES
AT FULL SIZE
(IF NOT 2"-SCALE ACCORDINGLY)

FILE 5476
DRAWN H.K./TOH
DESIGNED MBC
CHECKED

MCWD CONNECTION FACILITY

**MONTEREY REGIONAL
WATER POLLUTION CONTROL AGENCY
MONTEREY COUNTY, CALIFORNIA**

GENERAL

LANDSCAPE PLANTING PLAN

SCALE
1" = 10'
DRAWING NUMBER
G102
SHEET NUMBER